
CONSTRUCTION PLANS

ST. PETERSBURG VETERANS ADMINISTRATION REGIONAL OFFICE ADDITIONAL PARKING LOTS



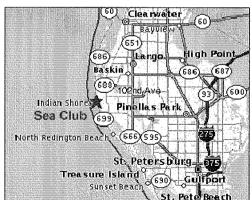


PINEALLAS, COUNTY

NOT TO SCALE

OWNER/DEVELOPER: VETERAN HEALTHCARE SYSTEM 9500 BAY PINE BLVD BAY PINES, FLORIDA 33744 727- 398-6661



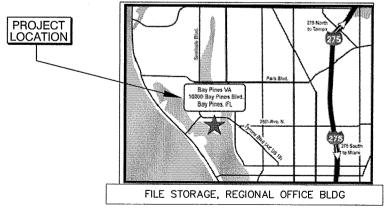

LOCATION MAP

SECTION 2, TWP 31. S, RGE. 15 E PINELLAS COUNTY, FLORIDA NOT TO SCALE

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1	SWFWMD SUBMITTAL	PEM	9-29-2008	
NO.	DESCRIPTION	BY	DATE	

VETERANS ADMINISTRATION SERVICES

ADDITIONAL PARKING LOTS



Civil Engineering • Transportation Environmental • Planning

20203 Cortez Boulevard Brooksville, Florida, 34601 www.tbegroup.com - 352.754.4551 License No. 3843 THOMAS M. ROSE, PE DATE

IC NO 62860

DESIGNED
TMR
DRAWN
PEM
Q.C.

APPROVED

COVER SHEET

PROJECT NO: 00081.001.00 DATE:

AUGUST 2008 SHEET NO: G1 00

PINELLAS COUNTY GENERAL NOTES

- ALL STATIONS AND OFFSETS REFER TO CONSTRUCTION REFERENCE LINE, UNLESS OTHERWISE NOTED
- SURVEY FOR THIS PROJECT WAS PREPARED BY THE TBE GROUP SURVEY & SUE DEPARTMENT.
- ATTENTION IS DIRECTED TO THE FACT THAT THESE PLANS MAY HAVE BEEN ALTERED IN SIZE BY REPRODUCTION. THIS MUST BE CONSIDERED WHEN OBTAINING SCALED DATA.
- THE CONTRACTOR SHALL FIELD VERIFY ANY AND ALL EXISTING CONDITIONS PRIOR TO COMMENCING CONSTRUCTION, AND SHALL NOTIFY THE ENGINEER PROMPTLY OF ANY DISCREPANCIES.
- THE CONSTRUCTION LENGTHS INDICATED IN THESE PLANS ARE APPROXIMATE. ACTUAL LIMITS MAY BE SET IN THE FIELD AS DIRECTED BY THE ENGINEER.
- 6 LOCATIONS FLEVATIONS AND DIMENSIONS OF EXISTING LITHLITIES STRUCTURES AND LOCATIONS, ELEVATIONS AND DIMENSIONS OF EXISTING UTILITIES, STRUCTURES, AND OTHER FEATURES ARE SHOWN ACCORDING TO THE BEST INFORMATION AVAILABLE AT THE TIME THESE DRAWNOS WERE PREPARED, BUT DO NOT PURPORT TO BE ABSOLUTELY CORRECT. THE INDICATED LOCATION OF UNDERGROUND UTILITIES, STRUCTURES, AND FACILITIES IS APPROXIMATE, AND REFLECTS THE BEST INFORMATION AVAILABLE FROM SURVEYS AND RECORDS. THE CONTRACTOR SHALL BE RESPONSIBLE FOR DETERMINING THE EXACT SIZE, LOCATION, DEPTH, HEIGHT, ELEVATION, DIMENSION, AND EXTENT OF ALL UNDERGROUND AND OVERHEAD FACILITIES AND OTHER FEATURES AFFECTING HIS WORK PRIOR TO PROCEEDING WITH ANY CONSTRUCTION ACTIVITY THAT MAY AFFECT SUCH FACILITIES. THE CONTRACTOR SHALL BE RESPONSIBLE FOR ANY DAMAGE CAUSED BY FAILURE TO COMPLY WITH THEFE INSTRUCTIONS FAILURE TO COMPLY WITH THESE INSTRUCTIONS
- THE CONTRACTOR MUST USE EXTREME CARE IN THE INSTALLATION OF STRUCTURES AND PIPING, DUE TO THE CLOSE PROXIMITY OF OVERHEAD AND UNDERGROUND POWER LINES.
- 8. THE LOCATION AND ELEVATION OF THE PROPOSED AMENITIES, AS SHOWN ON THE PLANS, IS FOR GRAPHICAL ORIENTATION PURPOSES ONLY. ACTUAL LOCATION OF THE PROPOSED AMENITES IS TO BE DETERMINED IN THE FIELD UTILIZING THE MINIMUM STANDARDS DEPICTED ON THE PLANS AND THE EXISTING TOPOGRAPHY AND PHYSICAL FEATURES FOUND IN THE FIELD. THE CONTRACTOR SHALL OBTAIN APPROVAL FROM THE PINELLAS COUNTY INSPECTOR/ENGINEER OF THE ACTUAL LAYOUT PROPOSED PRIOR TO ORDERING OF MATERIALS AND/OR COMMENCEMENT OF WORK.
- SEPARATE PAYMENT SHALL BE MADE ONLY FOR THE ITEMS OF WORK LISTED AND IDENTIFIED BY THE APPROPRIATE PAY ITEM ON THE BID FORM. THE COST OF ANY RELATED WORK NOT SPECIFICALLY IDENTIFIED, BUT WHICH IS REQUIRED FOR SATISFACTORY COMPLETION OF THE WORK, SHALL BE CONSIDERED TO BE INCLUDED IN THE CONTRACT PRICE FOR THE APPROPRIATE BID ITEM.
- THE CONTRACTOR'S ATTENTION IS DIRECTED TO THE FACT THAT ALL CONSTRUCTION ACTIVITIES SHALL CONFORM TO PINELLAS COUNTY CODE, CHAPTER 58, ENVIRONMENT, ARTICLE XII NOISE, SECTION 58-441 THROUGH 58-454.
- 11. THE CONTRACTOR SHALL HAVE A FOREMAN, OR RESPONSIBLE PARTY, ON SITE AT ALL TIMES WHEN WORK IS BEING PERFORMED. ALL WORKERS ON THE JOB SITE WILL BE COURTEOUS TO THE PUBLIC AT ALL TIMES, AND SHALL REFER ANY QUESTIONS OR CONCERNS TO THE CONTRACTOR'S FOREMAN OR THE COUNTY INSPECTOR. THE FOREMAN SHALL SPEAK AND UNDERSTAND ENGLISH AND SHALL BE AVAILABLE AT ALL TIMES FOR TIMELY RESOLUTION OF PROJECT RELATED ISSUES. THE CONTRACTOR MUST PROVIDE A 24 HOUR EMERGENCY PHONE NUMBER TO THE COUNTY INSPECTOR.
- 12. THE CONTRACTOR IS RESPONSIBLE TO PRACTICE AND ENFORCE ALL LOCAL AND STATE JOB AND CONSTRUCTION SAFETY LAW'S AND REGULATIONS, ESPECIALLY OSHA, WITH REGARDS TO CONSTRUCTION PRACTICES AND PROCEDURES. ANY VIOLATION OF THESE LAWS WILL BE REPORTED TO THE AUTHORITIES.

MAINTENANCE OF TRAFFIC

- 13. THE COST OF MAINTENANCE OF TRAFFIC OPERATIONS SHALL BE INCLUDED UNDER THE LUMP SUM PAY ITEM FOR MAINTENANCE OF TRAFFIC, UNLESS A SEPARATE PAY ITEM IS
- 14. THE CONTRACTOR SHALL PROVIDE FOR THE SAFE MOVEMENT OF PEDESTRIANS AND VEHICLES THROUGHOUT ALL PHASES OF CONSTRUCTION, INCLUDING DELIVERIES AND DROP-OFFS IN WORK ZONES. THE CONTRACTOR SHALL FURNISH, ERECT AND MAINTAIN ALL NECESSARY TRAFFIC CONTROL AND SAFETY DEVICES, IN ACCORDANCE WITH THE U.S. DEPARTMENT OF TRANSPORTATION "MANUAL ON UNIFORM TRAFFIC CONTROL DEVICES" AND THE CURRENT FLORIDA DEPARTMENT OF TRANSPORTATION "ROADWAY AND DESIGN STANDARDS. INDEX SERIES 600", AS AMENDED BY THE SPECIFICATIONS FOR THIS PROJECT.
- 15. THE SEQUENCE OF CONSTRUCTION AND METHODS DESCRIBED IN THIS PLAN SET, IF PROVIDED, IS A SUGGESTED MAINTENANCE OF TRAFFIC SCHEME. THE CONTRACTOR HAS THE OPTION, AT HIS EXPENSE, TO SUBMIT FOR APPROVAL TO THE PINELLAS COUNTY PUBLIC WORKS - TRANSPORTATION ENGINEERING DIVISION, HIS OWN "TRAFFIC CONTROL THROUGH WORK ZONE" PLANS, PRIOR TO CONSTRUCTION. ALL CONTRACTOR PROPOSED THROUGH WORK ZONE PLANS, PRIOR TO CONSTRUCTION. ALL CONTRACTOR PROPOSEI TRAFFIC CONTROL PLANS/SCHEMES MUST BE SIGNED AND SEALED BY A FLORIDA REGISTERED PROFESSIONAL ENGINEER, AND SHALL BE IN ACCORDANCE WITH FDOT INDEX 600 SERIES REQUIREMENTS. ACCESS SHALL BE CONTINUOUSLY MAINTAINED AT ALL SIDE STREETS AND DRIVEWAYS FOR THE DURATION OF THE PROJECT, UNLESS PREVIOUSLY APPROVED BY PINELLAS COUNTY.
- 16. UPON WRITTEN APPROVAL BY PINELLAS COUNTY, THE CONTRACTOR MAY CLOSE TO THRU-TRAFFIC THAT PORTION OF SIDE STREETS WITHIN THE LIMITS OF CONSTRUCTION.

 ACCESS FOR LOCAL TRAFFIC WITH DESTINATIONS WITHIN THE PROJECT LIMITS SHALL BE

 MAINTAINED. IF IT BECOMES NECESSARY DURING CONSTRUCTION TO TEMPORARILY PROHIBIT ACCESS TO LOCAL TRAFFIC, THE CONTRACTOR SHALL, ON EACH SEPARATE OCCASION, NOTIFY ALL AFFECTED PROPERTY OWNERS AND AREA EMERGENCY SERVICES AT LEAST THREE DAYS (72 HOURS) IN ADVANCE.
- 17. FOR SIDE STREET INTERSECTIONS, LANE CLOSURES SHALL BE LIMITED TO ONE LANE AT ALL TIMES. AT A MINIMUM, ONE-LANE, TWO-WAY OPERATION SHALL BE MAINTAINED THROUGH THE USE OF FLAGGERS. TWO-LANE, TWO-WAY OPERATION SHALL BE MAINTAINED DURING PERIODS OF LANE CLOSURE RESTRICTIONS, AND WHEN CONSTRUCTION ACTIVITIES ARE BEYOND THE LIMITS OF THE INTERSECTIONS.
- DURING PERIODS OF LANE CLOSURES, THE CONTRACTOR SHALL PROVIDE A FDOT-CERTIFIED WORK SITE TRAFFIC SUPERVISOR FOR THE INSTALLATION, MAINTENANCE, AND REMOVAL OF TRAFFIC CONTROL DEVICES (E.G. BARRICADES, SIGNS, ARROW PANELS, ETC.) AS OUTLINED IN THE FDOT STANDARD SPECIFICATIONS AND THE FDOT ROADWAY AND TRAFFIC DESIGN STANDARDS.

- THE CONTRACTOR SHALL NOTIFY ALL LOCAL LAW ENFORCEMENT PRIOR TO A LANE CLOSURE THAT WILL EXCEED TWO HOURS.
- 20. WHEN CONSTRUCTION EQUIPMENT IS BEING DRIVEN OR TRANSPORTED ON THE OPEN TRAVEL LANES, THE CONTRACTOR SHALL UTILIZE FDOT INDEX 619.
- 21. TRAFFIC CONDITIONS, ACCIDENTS, AND OTHER UNFORESEEN EMERGENCY CONDITIONS IRAFFIC CONDITIONS, ACCIDENTS, AND CHIER UNIFORESEEN EMERGENCY CONDITIONS MAY REQUIRE THE ENGINEER TO RESTRICT OR REMOVE LANE CLOSURE OR CHANNELIZATION. UNDER THESE CONDITIONS. THE CONTRACTOR SHALL RESPOND AND PROVIDE ADJUSTMENTS AS DIRECTED BY THE ENGINEER WITHOUT DELAY. THE CONTRACTOR SHALL ALSO RESPOND WITH THE CONSTRAINTS OUTLINED IN THE STANDARD SPECIFICATIONS UPON NOTIFICATION BY THE ENGINEER TO ANY REQUESTS FOR CORRECTION, IMPROVEMENT, OR MODIFICATION TO THE TRAFFIC CONTROL PLAN AND/OR DEVICES. THE COST OF THIS SERVICE SHALL BE INCLUDED IN THE LUMP SUM PRICE FOR MAINTENANCE OF TRAFFIC

- 22. EXCEPT WHERE THE PLANS AND SPECIFICATIONS PROVIDE THAT SUCH WORK SHALL BE PERFORMED UNDER THE CONTRACT FOR THIS PROJECT, ALL UTILITIES INTERFERING WITH CONSTRUCTION SHALL BE REMOVED, RELOCATED, OR ADJUSTED BY THEIR OWNERS, AT THEIR EXPENSE. THE CONTRACTOR SHALL ARRANGE HIS SCHEDULE TO ALLOW UTILITY OWNERS TIME FOR THE NECESSARY RELOCATION AND ADJUSTMENT OF UTILITIES AND
- 23. ABOVE GROUND AND/OR UNDERGROUND UTILITIES MAY BE IN THE AREA OF THIS PROJECT PROCEED WITH CAUTION THE CONTRACTOR SHALL CALL "SUNSHINE STATE ONE CALL" AND THE UTILITY OWNERS IN ADVANCE OF BEGINNING WORK, IN ACCORDANCE WITH CHAPTER 556, FLORIDA STATUTES, UNDERGROUND FACILITY DAMAGE PREVENTION & SAFETY. ALL UTILITY OWNERS MAY NOT BE A MEMBER, REQUIRING DIRECT CONTACT. THE CONTRACTOR SHALL FURTHER COORDINATE WITH UTILITY OWNERS TO RESOLVE CONFLICTS THAT MAY ARISE IN THE FIELD DURING CONSTRUCTION. THE CONTRACTOR WILL BE RESPONSIBLE FOR ANY UTILITIES DAMAGED AS A RESULT OF THE CONTRACTOR'S FAILURE TO CALL "SUNSHINE STATE ONE CALL" AND THE UTILITY OWNERS.
- 24. THE CONTRACTOR IS REQUIRED TO COORDINATE AND/OR PROVIDE FOR THE BRACING/SUPPORT OF EXISTING UTILITY POLES WITH THE UTILITY OWNERS, PRIOR TO THE COMMENCEMENT OF EXCAVATION/CONSTRUCTION ACTIVITIES.
- 25. THE CONTRACTOR SHALL PROVIDE TEMPORARY FACILITIES AS REQUIRED TO ISOLATE PIPELINES INSTALLED UNDER THIS CONTRACT FOR THE PERFORMANCE OF TESTING UNDER THIS CONTRACT. LIKEWISE, PROVIDE TEMPORARY FACILITIES AS REQUIRED TO MAINTAIN WASTEWATER SERVICE THROUGHOUT THE CONSTRUCTION PERIOD.
- 26. ALL EXISTING WATER MAINS, SANITARY SEWER LINES, WATER/SEWER PUMP STATIONS AND OTHER UTILITIES SHALL REMAIN IN SERVICE UNTIL THE RELOCATED UTILITIES ARE PLACED IN SERVICE. COORDINATE ALL UTILITY RELATED CONSTRUCTION ACTIVITIES WITH
- 27. ALL CONSTRUCTION WITHIN THE RIGHT-OF-WAY WILL BE IN ACCORDANCE WITH THE PRACTICES REQUIRED BY PINELLAS COUNTY LAND DEVELOPMENT CODE. ARTICLE V.
 - SECTION 170-266 THROUGH 170-276, ALONG WITH THE FDOT UTILITY ACCOMMODATION
- 28. CONTRACTOR WILL NOTIFY THE RESPONSIBLE UTILITY FOR RELOCATION OF METER BOXES FOR DRINKING WATER AND RECLAIMED WATER SERVICES.

DRAINAGE AND EROSION CONTROL

- 29. POLYVINYL CHLORIDE PIPE MUST CONFORM TO (P.V.C.) (A.S.T.M. F 949) 6" TO 36".
- 30. STATION LOCATIONS FOR STORM DRAIN INLETS AND MANHOLES REFERENCE THE CENTER OF THE SPECIFIED STRUCTURE BOTTOM. FOR PIPES WITH MITERED END SECTIONS, THE PROPOSED LENGTHS SHOWN ON THE PLANS INCLUDE THE LENGTH OF THE MITERED END SECTION. PAYMENT FOR PIPE SHALL NOT INCLUDE THE LENGTH OF THE MITERED END SECTION, AS SPECIFIED BY DIMENSION "F" AS SHOWN IN FDOT INDEX 272 AND 273. PAYMENT SHALL BE FROM INSIDE STRUCTURE WALL TO INSIDE STRUCTURE WALL, INCLUDING STRAIGHT OR U TYPE WALLS. ANY EXTRA PIPE LENGTH LISTED SHALL BE CONSIDERED CONTINGENT
- 31. CONFLICTS OF WATER OR SANITARY SEWER FORCE MAIN LINES WITH SANITARY GRAVITY LINES OR STORM SEWER SYSTEMS ARE TO BE RESOLVED BY ADJUSTING WATER OR FORCE MAIN LINES AS NECESSARY.
- 32. THE CONTRACTOR MUST COORDINATE THE RELOCATION OF ALL WATER, SANITARY SEWER, OR OTHER UTILITIES WITH THE OWNER.
- 33. WHERE IT IS NECESSARY TO DEFLECT PIPE EITHER HORIZONTALLY OR VERTICALLY, PIPE JOINT DEFLECTION SHALL NOT EXCEED 80% OF THE MAXIMUM VALUES SPECIFIED IN AWWA C-600-82 OR 80% OF THE PIPE MANUFACTURER'S MAXIMUM RECOMMENDED DEFLECTION, WHICHEVER IS MOST STRINGENT.
- 34. ALL EXISTING PIPES WITHIN THE AFFECTED RIGHT-OF-WAY CORRIDOR ARE TO REMAIN UNLESS OTHERWISE NOTED IN THE PLAN VIEW OR IN THE CROSS SECTIONS.
- 35. UNDERDRAINS SHALL BE CONSTRUCTED IN ACCORDANCE WITH PINELLAS COUNTY STANDARD CONSTRUCTION DETAILS, INDEXES 1281, 1282, AND 1290
- 36. UNDERDRAIN CLEANOUT PLUGS SHALL BE INSTALLED IN THE UPSTREAM ENDS OF UNDERDRAINS WHEREVER THE UPSTREAM END IS CONNECTED TO A STORM WATER INLET STRUCTURE OR JUNCTION BOX. UNDERDRAIN PLUGS SHALL BE "T-GRIPPER MECHANICAL PLUGS WITHOUT BYPASS" OR APPROVED EQUAL, AND SHALL BE CONSIDERED INCIDENTAL TO THE COST OF THE UNDERDRAIN PIPE.
- 37. ALL STORM SEWER INLET, MANHOLE AND JUNCTION BOX COVER LIDS SHALL BE FABRICATED AND STAMPED AS DETAILED IN THE PINELLAS COUNTY STANDARD CONSTRUCTION DETAILS, INDEX 1250, UNLESS SPECIFIED OTHERWISE IN THE
- 38. ALL EXISTING AND PROPOSED UTILITY AND STORM SEWER STRUCTURES WHOSE TOPS WILL BE EXPOSED WITHIN ANY SIDEWALK OR PAVED AREA SHALL BE U.S.F. TYPE X OR COVERS OUTSIDE SIDEWALK OR PAVED AREA SHALL BE U.S.F. TYPE BJ OR EQUAL.
- 39. IN ACCORDANCE WITH FDOT INDEX 205 AND FDOT STANDARD SPECIFICATION 2000 - SECTION 941, ALL PROPOSED STORM DRAIN PIPES WILL BE REINFORCED CONCRETE (RCP) CLASS III UNLESS OTHERWISE SPECIFIED.

- 40. ALL GRATES FOR DITCH BOTTOM INLETS ARE TO BE HOT DIPPED GALVANIZED STEEL, AFTER FABRICATION, PER FDOT INDEX 232 AND 233, AND SHALL BE SECURED TO THE STRUCTURES PER PINELLAS COUNTY STANDARD CONSTRUCTION DETAILS, INDEX 1295. ALL INLET STRUCTURES SHALL BE DESIGNED FOR H-20 LOADING.
- 41. ALL DITCH BOTTOM INLETS SHALL BE MODIFIED WITH "THIN WALL PRECAST OPTION" AS SHOWN IN FDOT INDEX 201, UNLESS FIELD CONDITIONS REQUIRE CAST IN PLACE
- 42. THE COST ASSOCIATED WITH THE USE OF CONCRETE/CLOTH PIPE JACKETS/COLLARS AS PER LATEST FDOT SPECIFICATION SHALL BE INCIDENTAL TO THE WORK BEING PERFORMED AND SHALL NOT BE PAID FOR SEPARATELY
- 43. THE ITEM FOR RIP RAP RUBBLE SHALL USE NATURAL BROKEN STONE AS REQUIRED IN SECTION 530- 2000. BROKEN CONCRETE SHALL NOT BE ACCEPTED OR USED.
- 44. IN WORKING NEAR A WETLAND, THE CONTRACTOR MUST COMPLY WITH REQUIREMENTS OF SECTION 3.2.4.1 CHAPTER B (SHORT TERM WATER QUALITY CONSIDERATIONS), SWEWND

CLEARING AND GRUBBING

- 45. THE CONTRACTOR SHALL ONLY REMOVE TREES DESIGNATED FOR REMOVAL IN THE PLAN, OR AS DIRECTED BY THE ENGINEER. CONTRACTOR IS TO OBTAIN THE TREE REMOVAL PERMIT FROM PINELLAS COUNTY DEPARTMENT OF ENVIRONMENTAL MANAGEMENT. TREE REMOVAL SHALL BE PAID FOR UNDER THE PAY ITEM CLEARING AND GRUBBING.
- 46. WHERE EXCAVATION IS REQUIRED FOR CONSTRUCTION OF SIDEWALK, STORMWATER STRUCTURES, PIPES, STUMPS, AND ROOTS, ETC., SHALL BE REMOVED COMPLETELY FROM THE SIDEWALK AREA. ALL STUMPS WITHIN THE PROJECT LIMITS SHALL BE REMOVED COMPLETELY AND REPLACED WITH COMPACTED BACKFILL BEFORE THE AREA IS FILLED. TREE ROOTS IN AREA OF PROPOSED SIDEWALK, RAMP, OR DRIVEWAY
 REPLACEMENT SHALL BE GROUND OUT TO A DEPTH OF 6" BELOW BOTTOM OF NEW SDEWALK OR DRIVEWAY. ALL PRUNED ROOT DEBRIS SHALL BE REMOVED FROM THE SUB-BASE MATERIAL PRIOR TO POURING CONCRETE, ASPHALT, OR APPLICATION OF OTHER SPECIFIED MATERIALS. THIS WORK SHALL BE INCLUDED AND PAID FOR UNDER THE PAY ITEM CLEARING AND GRUBBING.
- 47. ALL STUMPS, ROOTS, AND OTHER DEBRIS PROJECTING THROUGH OR APPEARING ON THE SURFACE OF THE GROUND SHALL BE REMOVED TO A DEPTH OF 1-FOOT BELOW THE COMPLETED SURFACE. THIS WORK SHALL BE INCLUDED IN AND PAID FOR UNDER THE PAY ITEM CLEARING AND GRUBBING.
- 48. THE CONTRACTOR SHALL REMOVE ALL DRIVEWAYS, SIDEWALKS, CURBS, AND ALL ABANDONED UTILITY LINES, PIPES, STRUCTURES, FLUMES AND OTHER SUBTERRANEAN OBJECTS TO A MINIMUM DEPTH OF FOUR (4) FEET BELOW GRADE, OR AS OTHERWISE DIRECTED BY THE ENGINEER. THIS WORK SHALL BE INCLUDED IN AND PAID FOR UNDER THE PAY ITEM CLEARING AND GRUBBING
- 49. ALL MATERIALS NOT CLAIMED BY THE COUNTY SHALL BECOME THE PROPERTY OF THE CONTRACTOR. AND SHALL BE DISPOSED OF BY THE CONTRACTOR IN AREAS PROVIDED BY THE CONTRACTOR. THIS WORK SHALL BE INCLUDED IN AND PAID FOR UNDER THE PAY ITEM CLEARING AND GRUBBING.
- 50. THE CONTRACTOR SHALL VERIFY THE PROPER WORKING ORDER OF SPRINKLER THE CONTRACTOR SHALL VERIFY THE PROPER WORKING ORDER OF SPRINKLER
 SYSTEMS AFFECTED BY CONSTRUCTION, BOTH PRIOR TO AND AFTER
 CONSTRUCTION. THE CONTRACTOR WILL CAREFULLY REMOVE IN THEIR ENTIRETY AND CAP,
 WITHOUT DAMAGE, ANY EXISTING SPRINKLER SYSTEM LOCATED, WITHIN THE RIGHT-OF-WAY,
 IN THE AREA TO BE CLEARED AND GRUBBED, EXCAVATED, OR TRENCHED IN PREPARATION
 FOR CONSTRUCTION ACTIVITIES. THIS WORK SHALL BE INCLUDED IN AND PAID FOR UNDER THE PAY ITEM CLEARING AND GRUBBING.
- 51. THE CONTRACTOR SHALL REPAIR ALL SPRINKLER SYSTEMS LOCATED ON PRIVATE PROPERTY, AND LYING OUTSIDE THE AREA OF CONSTRUCTION, WHICH MAY BECOME DAMAGED AS A RESULT OF CONSTRUCTION OF THIS PROJECT. SUCH REPAIR MUST OCCUR IN A TIMELY MANNER, BUT IN ALL CASES PRIOR TO FINAL PUNCH LIST INSPECTION OF THE PROJECT. THERE IS NO PAY ITEM FOR THE REPAIR OF SPRINKLER SYSTEMS, THE COST OF THIS REPAIR IS AT THE EXPENSE OF THE CONTRACTOR.
- 52. IF APPLICABLE, MAILBOXES SHALL BE RELOCATED IN ACCORDANCE WITH FDOT INDEX 532. RELOCATION OF MAILBOXES, AS REQUIRED OR WHERE CALLED OUT ON THE PLANS, WILL BE INCLUDED IN AND PAID FOR UNDER THE PAY ITEM CLEARING AND GRUBBING.

EXCAVATION, GRADING

- 53. ALL SUB-BASES SHALL BE OF GOOD CLEAN ACCEPTABLE MATERIAL COMPACTED TO MAXIMUM DENSITY AS DETERMINED BY AASHTO T-99, IN ACCORDANCE WITH FDOT STANDARD SPECIFICATIONS FOR ROAD AND BRIDGE CONSTRUCTION.
- 54. ALL AREAS OF EXPOSED EARTH RESULTING FROM CONSTRUCTION ACTIVITIES SHALL BE SODDED AS DIRECTED BY THE ENGINEER. SEEDING AND MULCHING SHALL BE APPLIED ONLY WHERE SPECIFICATIONS, OR WHERE SPECIFICATIONS, OR WHERE SPECIFICATION DIRECTED BY THE ENGINEER.
- 55. THE CONTRACTOR WILL BACKFILL AREAS TO BE SODDED WITH CLEAN FILL TO MAINTAIN PROPER GRADE OF PLANTING AREAS, AND THE SOD SHALL BE PROPERLY CUT-IN AND TAMPED, THE COST OF WHICH IS INCLUDED IN THE PAY ITEM FOR SODDING (SY).
- 56. SOD STABILIZATION SHALL OCCUR WITHIN 72 HOURS OF ACHIEVING FINAL GRADE.
 ALL SLOPES STEEPER THAN 3:1 SHALL INCLUDE SOD STAPLING OR STAKING, THE COST
 OF WHICH IS INCLUDED IN THE PAY ITEM FOR SODDING (SY).
- 57. THE CONTRACTOR SHALL PROVIDE ALL SHEETING, SHORING, AND BRACING REQUIRED TO PROTECT ADJACENT STRUCTURES OR TO MINIMIZE TRENCHWIDTH. WHERE A SEPARATE PAY ITEM IS NOT PROVIDED, THE COST OF ALL SHEETING, SHORING, AND BRACING REQUIRED SHALL BE INCLUDED IN THE CONTRACT PRICE FOR THE ITEM OF WORK FOR WANDED SHORING ENDERDED SHOULD SHORING SHO WHICH SHEETING, SHORING, AND BRACING IS REQUIRED.
- 58. WATER FOR SODDING SHALL BE APPLIED ACCORDING TO THE FDOT STANDARD SPECIFICATION FOR ROAD AND BRIDGE CONSTRUCTION, SECTION 575, AND SHALL BE PAID FOR UNDER THE PAY ITEM SODDING (SY).
- 59. WATER FOR SEEDING AND MULCHING SHALL BE APPLIED ACCORDING TO THE FDOT STANDARD SPECIFICATION FOR ROAD AND BRIDGE CONSTRUCTION, SECTION 570, AND SHALL BE PAID FOR UNDER THE PAY ITEM SEEDING AND MULCHING (SY).

PEM 9-29-200 1 SWFWMD SUBMITTAL NO. DESCRIPTION BY DATE

VETERANS ADMINISTRATION **SERVICES**

ADDITIONAL PARKING LOTS



Civil Engineering • Transportation Environmental • Planning

20203 Cortez Boulevard Brooksville, Florida, 34601 vw.tbegroup.com - 352.754.4551 License No. 3843

THOMAS M. ROSE PE LIC. NO.: 62860

DRAWN PEM Q.C.

DESIGNED

APPROVED

DATE

GENERAL NOTES

00081 001 00

SHEET NO:

AUGUST 2008

G1.01

- 60. UNSUITABLE MATERIAL SHALL BECOME THE PROPERTY OF THE CONTRACTOR AND SHALL BE DISPOSED OF OFF-SITE, AT A SUITABLE SITE PROVIDED BY THE CONTRACTOR. THE CONTRACTOR SHALL BE RESPONSIBLE FOR ANY AND ALL PERMITS AND PERMITTING FEES REQUIRED FOR THE TRANSPORT AND DISPOSAL OF UNSUITABLE MATERIAL.
- ALL EXCESS EXCAVATED SUITABLE AND UNSUITABLE MATERIAL NOT CLAIMED BY THE COUNTY SHALL BECOME THE PROPERTY OF THE CONTRACTOR, AND SHALL BE DISPOSED OF BY THE CONTRACTOR IN AREAS PROVIDED BY THE CONTRACTOR. PAYMENT SHALL BE INCLUDED IN THE PAY ITEM GRADING (LUMP SUM).
- 62. BORROW MATERIAL REQUIRED FOR CONSTRUCTION OF THE PROJECT SHALL BE PROVIDED BY THE CONTRACTOR FROM BORROW AREAS PROVIDED BY THE CONTRACTOR
- 63. EXCEPT FOR THE COST OF EXCAVATING UNSUITABLE MATERIAL AND THE COST OF FURNISHING, PLACING, AND COMPACTING FILL TO REPLACE UNSUITABLE MATERIAL, THE CONTRACT PRICE FOR GRADING SHALL INCLUDE THE COST OF ALL EMBANKMENT AND EXCAVATION GRADED CONNECTIONS FINAL DRESSING AND SIMILAR EARTHWORK OPERATIONS REQUIRED FOR THE COMPLETION OF THE PROJECT, UNLESS OTHERWISE DIRECTED BY THE ENGINEER.
- 64. ANY GRADING OR CONSTRUCTION DEPICTED ON THE PLANS BEYOND THE RIGHT-OF-WAY AND WITHIN THE LIMITS OF CONSTRUCTION IS TO BE PERFORMED ONLY AFTER RECEIPT OF PERMISSION FROM THE PROPERTY OWNER THROUGH A RIGHT OF ENTRY AGREEMENT AND/OR A SIDEWALK, UTILITY, OR DRAINAGE EASEMENT. ONLY AFTER NOTIFICATION BY THE ENGINEER THAT THE AGREEMENT/FASEMENT HAS BEEN OBTAINED. SHALL THE CONTRACTOR CONSTRUCT WITHIN THIS AREA. SHOULD THE ENGINEER FAIL TO OBTAIN THE PROPER AUTHORIZATION THE CONTRACTOR SHALL MODIFY THE CONSTRUCTION LIMITS. AS DIRECTED BY THE ENGINEER, IN ORDER TO KEEP WITHIN THE EXISTING
- 65. NO STOCK PILING OF MATERIAL IN ROADWAY, OR ON SIDEWALK, SHALL BE PERMITTED. ALL EXTRA DIRT AND/OR DEBRIS SHALL BE REMOVED DAILY AS A PART OF THE DAILY CLEAN UP. THE ROADWAY AND SIDEWALK SHALL BE SWEPT DAILY.
- 66. ALL ABANDONED PIPES OR STRUCTURES SHALL BE REMOVED BY THE CONTRACTOR PAVING, SIDEWALK, AND DRIVEWAY CONSTRUCTION
- 67. NO SURFACING SHALL BE APPLIED TO ANY MANHOLE COVERS, FRAMES, VALVE BOXES, GAS DROPS, ETC.
- 68. ALL EXISTING AND PROPOSED UTILITY AND STORM SEWER STRUCTURES WHOSE
 TOPS WILL BE EXPOSED WITHIN ANY SIDEWALK OR PAVED AREA SHALL BE ADJUSTED SO
 THAT THE TOP SURFACE OF COVERS OR FRAMES SHALL BE FLUSH WITH THE SIDEWALK OR PAVEMENT SURFACE. ALL EXISTING AND PROPOSED UTILITY AND STORM SEWER STRUCTURES WHOSE TOPS WILL BE EXPOSED WITHIN UNPAVED AREAS SUBJECT TO VEHICULAR BICYCLE, OR PEDESTRIAN TRAFFIC SHALL BE ADJUSTED SO THAT THE TOP SURFACE OR COVERS OR FRAMES SHALL BE NO MORE THAN ONE INCH ABOVE THE FINISHED GRADE. WHERE SODDING IS APPLIED, "FINISHED GRADE" SHALL BE THE NOMINAL HEIGHT OF GRASS AFTER THE SOD IS FIRMLY PLACED.
- 69. THE CONTRACTOR SHALL DELIVER ALL REMOVED CLEAN CONCRETE SIDEWALK. CURB, AND DRIVEWAY SECTIONS (MTH NO REINFORCING MATERIAL) TO THE FOLLOWING HIGHWAY DEPARTMENT DISTRICT MAINTENANCE YARD. DELIVERIES OF SURPLUS MATERIAL SHALL BE MONDAY THROUGH THURSDAY BETWEEN 7:30AM AND PINELLAS COUNTY HIGHWAY DEPARTMENT - (CENTRAL YARD) 22211 US HWY.
- 70. ALL EXCESS MILLINGS RESULTING FROM CONSTRUCTION ACTIVITIES SHALL REMAIN THE PROPERTY OF PINELLAS COUNTY AND SHALL BE DEPOSITED NEATLY IN THE FOLLOWING DESIGNATED SPOIL AREA. TRANSPORTING AND STOCKPILING SAID MATERIAL SHALL BE PAID FOR UNDER AND INCLUDED IN THE PAY ITEM CLEARING AND GRUBBING. DELIVERIES OF SURPLUS MATERIAL SHALL BE MONDAY THROUGH THURSDAY BETWEEN 7:30AM AND 4:30PM. PINELLAS COUNTY HIGHWAY DEPARTMENT STOCKPILE 12605 140TH STREET MODITY CLEARING TO BE TO THE TOTAL CLEARING THE PAY ITEM TO THE TOTAL CLEARING THE PAY ITEM TO THE TOTAL CLEARING THE PAY ITEM TO THE PA 12625 140TH STREET NORTH CLEARWATER, FL 33762.
- ANY PRIVATELY OWNED FEATURES LOCATED ON PRIVATE PROPERTY AND OUTSIDE THE DESIGNATED AREA OF CONSTRUCTION DAMAGED AS A RESULT OF CONSTRUCTION ACTIVITIES SHALL BE REPAIRED IN A TIMELY MANNER, AT THE EXPENSE OF THE
- 72. EXISTING PAVEMENT SHALL BE SAW-CUT IN PROPOSED PATCH AREAS TO A DEPTH REQUIRED FOR THE PROPOSED PAVEMENT AS SHOWN ON THE PLANS. THE COST SHALL BE INCLUDED IN THE PAY ITEM FOR ASPHALTIC CONCRETE.
- 73. ASPHALT USED FOR PATCHING OF ROADWAY FOR INSTALLATION OF DRIVEWAYS. SIDEWALK RAMPS AND CURB SHALL BE INCIDENTAL TO THE COST OF THE ITEM BEING INSTALLED. ASPHALT USED FOR PATCHING DRIVEWAYS SHALL BE INCLUDED IN THE PAY ITEM FOR THE CORRESPONDING ASPHALTIC CONCRETE TYPE, UNLESS OTHERWISE
- . ALL PROPOSED ASPHALT PATCH AND SURFACING OVERLAID ON EXISTING PAVEMENT SHALL BE FEATHERED SMOOTHLY INTO THE EXISTING PAVEMENT, AND MAY REQUIRE THE NEED FOR A MILLED BUTT-JOINT.
- 75. EXISTING ROADWAY MATERIALS SUCH AS SHELL, MARL, OR LIMEROCK SUITABLE FOR SUCH MAY BE UTILIZED IN THE PREPARATION OF STABILIZED SUBGRADE.
- THE CONTRACTOR SHALL DISTURB NO MORE GROUND THAN WHAT IS NECESSARY FOR CONSTRUCTION. NO OPEN EXCAVATED TRENCH, OR OTHER UNSAFE CONDITION, WILL BE LEFT OVERNIGHT. ALL WORK SITES WILL BE COMPLETELY RESTORED WITHIN SEVEN (7) CALENDAR DAYS OF THE CONCRETE POUR FOR SIDEWALK. THE INTENT OF THIS PROMISION IS TO "SAFE UP" THE PROJECT SITE AS WORK PROGRESSES, AND SHALL INCLUDE REMOVING FORMS, FILLING HOLES, GRADING, AND REMOVAL OF DEBRIS.
- SIDEWALK SHALL BE CONSTRUCTED ACCORDING TO FDOT INDEX 310, AND SIDEWALK SHALL BE CONSTRUCTED ACCORDING TO FIDDT INDEX 3104, AND SIDEWALK RAMPS SHALL BE CONSTRUCTED ACCORDING TO FDOT INDEX 304, UNLESS A SEPARATE DETAIL IS PROVIDED. SIDEWALK RAMPS SHALL BE CONSTRUCTED TO A MINIMUM THICKNESS OF SIX (6) INCHES AND SHALL BE REINFORCED WITH EITHER WELDED WIRE FABRIC OR REINFORCING STEEL BARS, AS SHOWN ON THE PLANS OR AS APPROVED BY THE ENGINEER. THE CONTRACTOR WILL INSTALL AN EXPANSION JOINT AT EACH END OF A CURB CUT.

- 78. THE CONTRACTOR WILL REQUEST A PRE-POUR INSPECTION BY THE DESIGNATED COUNTY INSPECTOR. THE CONTRACTOR SHALL NOT POUR ANY SIDEWALK OR SIDEWALK RAMP CONCRETE UNTIL A "PRE-POUR" INSPECTION FULLY APPROVES THAT ALL DE-ROOTING AND CLEARING AND GRUBBING REQUIREMENTS, IF ANY, ARE ALL DE-ROOTING AND CLEARING AND GRUBBING REQUIREMENTS, IF ANY, ARE PERFORMED IN ACCORDANCE WITH THIS SPECIFICATION, TO VERIFY THAT ALL FORM WORK IS SUFFICIENT, AND THAT THE SUBGRADE IS CUT TO THE PROPER DEPTH AND COMPACTED PROPERLY. WORK NOT IN ACCORDANCE WITH A COUNTY "POST-POUR" INSPECTION MAY REQUIRE THE COMPLETE REMOVAL OF REJECTED WORK OR RESULT IN A REDUCED PAYMENT OF THE DELIVERABLE.
- 79. ALL SIDEWALK DAMAGED BY THE CONTRACTOR OR SUBCONTRACTORS SHALL BE REPLACED AT THE EXPENSE OF THE CONTRACTOR, AT THE DIRECTION OF THE

SIGNS AND MARKINGS

- 80. ALL EXISTING SIGNS WITHIN THE PROJECT LIMITS SHALL REMAIN UNLESS OTHERWISE NOTED IN THE PLANS, OR AS DIRECTED BY THE ENGINEER. SIGN
- 81. ANY EXISTING SIGN TO REMAIN THAT IS DISTURBED OR RELOCATED DURING CONSTRUCTION SHALL BE RESET TO CURRENT STANDARDS FOR HEIGHT, OFFSET, AND METHOD OF INSTALLATION. COST OF THIS WORK SHALL BE REFLECTED IN THE PAY ITEM FOR RELOCATE EXISTING SIGN, SINGLE POST (ASSEMBLY). MULTIPLE SIGNS ON A SINGLE POST SHALL BE PAID FOR AS ONE ASSEMBLY.
- 82. CAUTION SHOULD BE EXERCISED WHILE RELOCATING EXISTING SIGNS SO AS TO PREVENT DAMAGE TO THE SIGNS. SIGNS DAMAGED BEYOND USE, AS DETERMINED BY THE ENGINEER, SHALL BE REPLACED BY THE CONTRACTOR AT HIS EXPENSE.
- 83. ALL SIGNS SHALL BE INSTALLED ACCORDING TO THE APPROPRIATE FOOT ROADWAY AND TRAFFIC DESIGN STANDARDS INDEX AND THE FOOT STANDARD SPECIFICATIONS FOR ROAD AND BRIDGE CONSTRUCTION, SECTION 700.
- 84. THE CONTRACTOR SHALL DELIVER AND DEPOSIT NEATLY AT THE FOLLOWING DESIGNATED SPOIL AREA, ANY TRAFFIC SIGN OR SIGNAL EQUIPMENT REMOVED AS A RESULT OF CONSTRUCTION ACTIVITIES. DELIVERIES OF SURPLUS MATERIAL SHALL BE MONDAY THROUGH THURSDAY BETWEEN 7: 30AM AND 4: 30PM. PINELLAS COUNTY HIGHWAY DEPARTMENT - (CENTRAL YARD) 22211 US HWY. 19 NORTH CLEARWATER, FL
- 85. CONTRACTOR SHALL INSTALL TEMPORARY PAINTED LANE STRIPING. PAVEMENT MARKINGS SHALL BE PLACED AS SHOWN ON THE PLANS, AND THE APPROPRIATE FDOT ROADWAY AND TRAFFIC DESIGN STANDARDS INDEX.
- 86. PAVEMENT MARKINGS ON NEW ASPHALT SHALL BE PAINT, AND NOT
- 87. CONTRACTOR SHALL USE W-SHAPE STEEL POSTS FOR MULTI-POST SIGNS. ALL POSTS FOR SINGLE COLUMN SIGNS SHALL BE ALUMINUM ROUND TUBE.
- 88. REFER TO FDOT ROADWAY AND TRAFFIC DESIGN STANDARDS, INDEX 17352 FOR RETRO— REFLECTIVE PAVEMENT MARKER PLACEMENT DETAILS.

SYMBOLOGY:

πι = telephone manhole

w = electric manhale = water valve = cedar, or as described, size noted = pine, size noted

= oak, size

= end of S.U.E. location, or as described

a = pkn&d 'the trav pt lb6668',
or as described A = 5/8' inc 'the trav pt 166668'

- = power pole = 6' conc bollard

€--- = guy anchor S.S? = flowline spot elevation

+935 = edge of pavement spot

aggs = back of curb spot 887 elevation

1435 = natural ground spot

SHEET LEGEND

	OTTLET LEGEND	
	EXISTING:	PROPOSED:
	: LOT LINES	: PROPOSED LINE (NEW)
	: PROPERTY BOUNDRY	:: PROPERTY BOUNDRY
	: CENTER LINE	: CENTER LINE
	: UTILITY EASEMENT	: UTILITY EASEMENT
	: SETBACK	: SETBACK
	: STORM SEWER	: STORM SEWER
	: WATER METER BOX	—SAN— : SANITARY
	: WATER VALVE	
	: FIRE HYDRANT	
	: METAL POLE	■ WM : WATER METER BOX
	: TELEPHONE JUNCTION BOX	₩w : WATER VALVE
	: CABLE TELEVISION BOX	™FH : FIRE HYDRANT
	: SANITARY SEWER MANHOLE	● BOW OFF
	: STORM DRAINAGE MANHOLE	™ TJB : TELEPHONE JUNCTION BOX
-x-	: WIRE FENCE	DICATY : CABLE TELEVISION BOX
-a-	: WOOD FENCE	S : SANITARY SEWER MANHOLE
-o-	: CHAIN LINK FENCE	STORM DRAINAGE MANHOLE
-ww-	: WATER MAIN	x- : WIRE FENCE
—P—	: OVERHEAD ELECTRIC LINE	: WOOD FENCE
-0- PP	: UTILITY OR GUY POLE (AS SHOWN)	o- : CHAIN LINK FENCE
☆ LP	: LIGHT POLE	ww : WATER MAIN
E	: ELECTRICAL TRANSFORMER	P- : OVERHEAD ELECTRIC LINE
	: GUY WIRE AND ANCHOR	->PP : UTILITY OR GUY POLE (AS SHOWN)
**	: BORING / SOIL TEST	≄Ψ : LIGHT POLE
		E : ELECTRICAL TRANSFORMER
		: GUY WIRE AND ANCHOR
		BORING / SOIL TEST
		: HOSE BIBB ASSEMBLY
	LEGEND:	
	asph = asphalt	
	bc = back of curb bfp = back flow preventer	
	bt = buried telephone	
	caty = cable television	
	conc = concrete dia = diameter	
	dip = cast iron pipe	
	elec = electric	ADDDE MATIONS
	elev = elevation ep = edge of pavement	ABBREVIATIONS
	ob loade or basement	

ABBREVIATIONS

	: DIMENSION DERIVED FROM PLAT INFORMATION
(M)	: DIMENSION DERIVED FROM FIELD MEASURED INFORMATION
(D)	
(c)	
L1	: LINE TABLE NUMBER
C1	: CURVE TABLE NUMBER
EP	
EX.	- · · · · ·
PC	: POINT OF CURVATURE
PΤ	: POINT OF TANGENCY
PCC	: POINT OF COMPOUND CURVATURE
PRC	: POINT OF REVERSE CURVATURE
RP	: RADIUS POINT
PLS	: PROFESSIONAL LAND SURVEYOR
Œ	: CENTERLINE
0.R.	: OFFICIAL RECORD BOOK
PP	: POWER POLE
PRCCF	: PUBLIC RECORDS OF CITRUS COUNTY, FLORIDA
PCP	
PRM	: PERMANENT REFERENCE MONUMENT
POC	: POINT OF COMMENCEMENT
P08	: POINT OF BEGINNING
TYP.	: TYPICAL
LB	: LICENSED BUSINESS
FB	: FIELD BOOK
NO	: NUMBER
CONC	: CONCRETE
MON	: MONUMENT
P/K	: TYPE OF NAIL
R/W	: RIGHT-OF-WAY
TJB	
	: CABLE TELEVISION BOX
	: TOE OF SLOPE
	=

CONTROL TABLE

SMH

MES

	CONTROL TABLE						
POINT	NORTHING	EASTING	ELEVATION	DESCRIPTION			
A1	4297.040	3990.410	8.43	SET PKN&D "TBE TRAV PT LB6668"			
A2	4813.420	4160.810	8.20	FND NAIL & FLASHER "GFY SURVEY"			
A3	4174.983	3836.844	8.61	SET PKN&D "TBE TRAV PT LB6668"			
A4	4321.144	3751.959	9.60	SET PKN&D "TBE TRAV PT LB6668"			
A5	4765.640	3207.115	9.81	SET 5/8" IRC "TBE TRAV PT LB6668"			
A6	4977.895	3372.696	10.39	SET 5/8" IRC "TBE TRAV PT LB6668"			
A7	4573 911	3901 391	10.43	SET 5/8" IPC "TRE TRAV DT L BEGGE"			

1 SWFWMD SUBMITTAL PEM 9-29-2008 NO. DESCRIPTION BY DATE

VETERANS ADMINISTRATION **SERVICES**

ADDITIONAL PARKING LOTS

- = water main

--- = sanitary sewer line

= overhead electric

— = buried telephone

-- = buried electric



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THOMAS M. ROSE, PF

DRAWN TMR PEM 0.0 DATE APPROVED

elev = elevation ep = edge of pavement find = found fl = flowline inv = invert irc = iron rod & cap ll = lane line p = light pole mh = man hole or = official record

pp = power pole
pvc = polyvinyl chloride
son = sanitory
sirc = set iron rod & cap
smh = sanitary manhole
ss = sanitary sewer
S.U.E. = subsurface utility
engineers
swik = sidewalk
tob = top of bank
tele = telephone

tos = toe of slope
vcp = vitrified clay pipe
w/ = with
wm = water main

SYC

LO

PO

TO

PA

MAG

TW

TREE ABBREVIATIONS

SYCAMORE OAK

: LIVE OAK

PIN OAK POST OAK

PALM

CEDAR

TWIN

MAGNOLIA

PINE

TURKEY OAK

pkn&d = parker kalon nail & disk pp = power pole

or = official record

GENERAL NOTES

TOP OF BANK

SANITARY MANHOLE

INVERT ELEVATION

MITERED END SECTION

ELEVATION


MANHOLE


ROJECT NO 00081.001.00 AUGUST 2008


G1.02


SHEET NO

SENERAL NOTES due LAST SAVED: Tue 10/28/08-1-38s PLOTTED: Tue 03

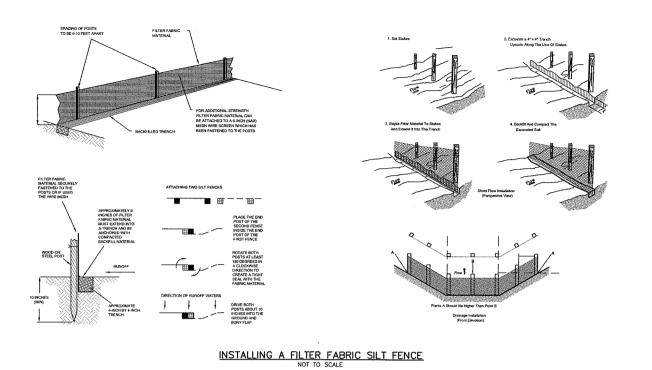

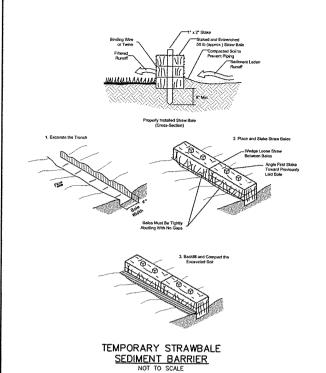

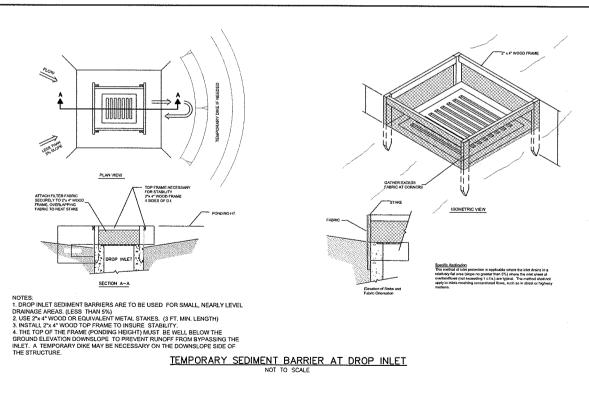

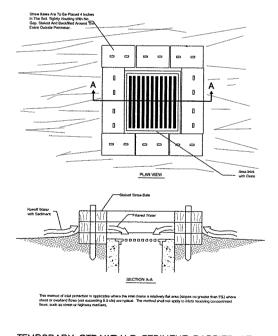

TEMPORARY STRAWBALE SEDIMENT BARRIER AT STORM DRAIN DROP INLET

EROSION CONTROL NOTES

- IT IS THE RESPONSIBILITY OF THE CONTRACTOR TO CONTROL AND PREVENT EROSION AND THE TRANSPORTATION OF SEDIMENT TO SURFACE DRAINS AND OUTFALLS. ALL EROSION CONTROLS SHALL FOLLOW FDEP SOIL EROSION CONTROL MEASURES.
- THE CONTRACTOR SHALL PROVIDE SILT BARRIERS TO CONTROL EROSION AND SEDIMENTATION FROM TAKING PLACE OUTSIDE THE LIMITS OF THE PROJECT. THE SILT BARRIERS SHALL BE PLACED IN ACCORDANCE WITH THE REQUIREMENTS OF FOOT INDEX NO. 102, 103 AND 104 OR AS DIRECTED BY THE CITY ENGINEER.
- 3. REQUIRED EROSION CONTROL MEASURES SHALL REMAIN INTACT THROUGHOUT CONSTRUCTION. FAILURE TO INSTALL OR PROPERLY MAINTAIN REQUIRED EROSION CONTROL WILL RESULT IN ENFORCEMENT ACTION WHICH MAY INCLUDE CITATIONS AS PROVIDED BY APPLICABLE LOCAL ORDINANCE AND CHAPTERS 400-4 ANO 407-6. F.A. INITIATION OF CIVIL PENALTY PROCEDURES PURSUANT TO SECTION 373.129. F.A.C. CAN RESULT IN A PENALTY NOT TO EXCEED SIGNOUP PER OFFERSE WITH EACH DATE DURING WHICH SUCH VIOLATION OCCURS CONSTITUTING A SEPARATE OFFENSE.
- 4. ALL WORK PERFORMED SHALL COMPLY WITH THE REGULATIONS AND ORDINANCES OF THE VARIOUS GOVERNMENTAL AGENCIES HAVING JURISDICTION OVER THE WORK.

		Ī
1 SWFWMD SUBMITTAL	PEM	9-29-2008
NO. DESCRIPTION	BY	DATE

VETERANS ADMINISTRATION SERVICES

ADDITIONAL PARKING LOTS



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DESIGNED TMR DRAWN PEM THOMAS M. ROSE, PE DATE LIC. NO.: 62860

APPROVED

ROJECT NO: 00081.001.00 AUGUST 2008 SHEET NO:

SC1.00

Ldwg LAST SAVED: Mon, 03/23/09-4:53p PLOTTED: Tue, 03/24/09-2:24p BY: trnr

EROSION CONTROL

STORMWATER POLLUTION PREVENTION PLAN

PROJECT NAME: VETERANS ADMINISTRATION SERVICES
ADDITIONAL PARKING LOTS

PROJECT ADDRESS: 9500 BAY PINES BOULEVARD ST. PETERSBURG, FL

OWNERS ADDRESS: 9500 BAY PINES BOULEVARD ST. PETERSBURG, FL

DESCRIPTION OF PURPOSE AND TYPES OF SOIL DISTURBING ACTIVITIES:

THE PROJECT WILL CONSIST OF: RELOCATING AN EXISTING DITCH SYSTEM AND CONSTRUCTION OF A GRAVEL PARKING LOT ON THE NORTH SIDE OF THE SITE ALSO, A DITCH SYSTEM ALONG THE SOUTH SIDE OF THE SITE WILL BE FILLED AND REPLACED WITH A 15" CULVERT TO PROVIDE CONVEYANCE.

SOIL DISTURBING ACTIVITIES WILL INCLUDE: CLEARING & GRUBBING SITE FOR AFOREMENTIONED PROPOSED CONSTRUCTION.

WETLAND/SURFACE WATER ACTIVITIES INCLUDE: NONE PROJECT AREA: 1.50 ACRES

SEQUENCE OF MAJOR ACTIVITIES

- 1. INSTALL STAKED SILT FENCE AS SHOWN ON THE EROSION CONTROL & DEMOLITION PLANS. 2. EXCAVATE RELOCATED DITCH SYSTEM AND INSTALL EXPLITATION SYSTEM 3. COMPLETE SITE PREPARATION PLAN, PAVING, GRADING, AND DRAINAGE PLAN, AND UTILITY

- 3. COMPLETE SITE PREPARATION PLAN, PAVING, GRADING, AND DRAINAGE PLAN, AND UTILITY ONSITE/OFFSITE PLANS, AND/OR WETLAND MITIGATION.

 4. INSTALL NEW STORM SYSTEMS, PARKING LOT, AND BOLLARDS.

 5. FILL AND GRADE DISTURBED AREAS.

 6. REPAIR ANY WASHED OUT AREAS, INSTALL PLANTING MATERIAL AS SHOWN ON LANDSCAPE PLAN, SOD, SEED, AND MULCH DISTURBED AREAS AS INDICATED ON PLANS.

 7. WHEN CONSTRUCTION ACTIVITY IS COMPLETE AND THE SITE STABILIZED, PEMOYE EROSION PROTECTION DEVICES AND CONSTRUCTION ENTRANCE AS REQUIRED.

NAME OF RECEIVING WATERS: THE PROPOSED IMPROVEMENTS WILL DISCHARGE INTO EXISTING STORMWATER MANAGEMENT SYSTEM THEN BAY PINES BOULFVARD

CONTROLS

EROSION AND SEDIMENT CONTROLS

STABILIZATION PRACTICES:
WIND EROSION STABILIZATION—THE CONTRACTOR SHALL DENUDE ONLY AREAS WHERE IT IS EXPECTED TO BE GRADED OR ALTERED WITHIN A TWO (2) WEEK TIME FRAME. FINAL GRADEINS SHALL BE PERFORMED AND TEMPORARY OR PERMANENT SOIL STABILIZATION SHALL BE APPLIED AREAS WHERE CONSTRUCTION OPERATIONS WILL BE CONTINUOUS, FUGITIVE DUST SHALL BE MANAGED BY APPLYING A WATER SPRAY TO SATURATE THE SURFACE SOILS. CONTINUOUSLY AND ADDITIONAL MEASURES MAY NEED TO BE TAKEN AND CONTROL OFF—SITE TRANSPORT OF UNACCEPTABLE LEVELS OF DUST BASED ON FLORIDA DEPARTMENT OF ENVIRONMENTAL PROTECTION SOIL, EROSION, AND SEDIMENT CONTROL

TEMPORARY STABILIZATION—FOP OF SOIL STOCK PILES AND DISTURBED PORTIONS OF THE SITE WHERE CONSTRUCTION ACTIVITY TEMPORARILY CEASES FOR AT LEAST 21 DAYS WILL BE STABILIZED WITH TEMPORARY CRASS AND MULCH NO LATER THAN 14 DAYS FROM THE LAST CONSTRUCTION ACTIVITY. CRASS SEED SHALL BE A MIXTURE OF 20 PARTS OF BERMUDA SEED AND 80 PARTS OF PERSACOLA BAHLA THE SEPARTE TYPES OF SEED USES SHALL BE THOROUGHLY DRY MIXED IMMEDIATELY BEFORE SOWING SEED WHICH HAS BECOME WET SHALL NOT BE USED. THE MULCH MATERIAL USED SHALL NORMALLY BE DRY MULCH. DRY MULCH SHALL BE STRAW OR HAY. CONSISTING OF OAT, RYE OR WHEAT STRAW, OR OF PANCOLA, PEANUT, COASTAL BERMUDA OR BAHAL GRASS HAY, ONLY UNDETERIORATED MULCH, WHICH CAN BE READILY CUT INTO THE SOIL, SHALL BE USED. AREAS OF THE SITE, WHICH ARE TO BE PAVED, WILL BE TEMPORABRLY STABILIZED BY APPLYING STABILIZATION AND BASE. TREE BARRICADES WHERE REQUIRED

PERMANENT STABILIZATION-DISTURBED PORTIONS OF THE SITE WHERE CONSTRUCTION ACTIVITIES PERMANENTLY CRASES SHALL BE STABILIZED WITH SOD NO LATER THAN 14 DAYS AFTER THE LAST CONSTRUCTION ACTIVITY.

STAKED SILT FENCES—THE STAKED SILT FENCES WILL BE CONSTRUCTED ALONG THE CONSTRUCTION LIMITS AS DEPICTED ON THE EROSION CONTROL & DEMOLITION PLANS, AND ON THE CONSTRUCTION PLANS. THESE DEVICES WILL STOP AND DIVERT RUNOFF TO THE EXISTING DITCHES.

TURBIDITY BARRIERS—THE TURBIDITY BARRIERS WILL BE CONSTRUCTED AS DEPICTED ON THE EROSION CONTROL & DEMOLITION PLANS, INSTALLATION OF TURBIDITY BARRIERS AT OFFSITE STORMWATER DISCHARGE LOCATIONS.

SOUTHWEST FLORIDA WATER MANAGEMENT DISTRICT - KEY PROVISIONS (IN ACCORDANCE WITH SUBSECTION 2.8.4 OF THE BASIS OF REVIEW FOR ENVIRONMENTAL RESOURCE PERMIT (ERP) APPLICATIONS) THE PERMITTEE SHALL AMEND THE CONSTRUCTION SURFACE WATER MANAGEMENT PLAN WHENEVER THE PROJECT IS ALTERED OR MODIFIED IN A MANNER THAT WILL RESULT IN:

(1) THE POTENTIAL DISCHARGE OF POLLUTANTS
(2) A CHANGE IN THE AMOUNT OF DISCHARGE
(3) A CHANGE IN THE NUMBER OF LOCATION OF STORM WATER DISCHARGE POINTS, OR
(4) ADVERSE IMPACTS TO WETLANDS, AND SUCH CHANGE(S) HAVE NOT OTHERWISE BEEN PREVIOUSLY ADDRESSED IN THE APPROVED PLAN.

THE PERMITTEE SHALL ALSO AMEND THE PLAN IF ITS IMPLEMENTATION DOES NOT ELIMINATE OR MINIMIZE EROSION AND SEDIMENT DEPOSITION, OFF-SITE FLOODING, ADVERSE IMPACTS TO WELLAND, OR VIOLATIONS OF STATE WATER OUALITY STANDARDS, AMENDMENTS TO THE PLAN SHALL BE PREPARED AND KEPT AS SEPARATE DOCUMENTS ALONG WITH THE ORIGINAL PLAN. ALL ALTERATIONS TO THE SYSTEM MUST BE SHOWN ON THE AMENDED PLAN ALONG WITH THE DOCUMENTATION OF REQUIRED APPROVAL(S).

OTHER CONTROLS

WASTE DISPOSAL

WASTE MATERIALS—ALL WASTE MATERIAL WILL BE COLLECTED AND STORED IN DUMPSTERS PER LOCAL SOLID WASTE REGULATIONS ALL TRASH AND CONSTRUCTION DEBRIS FROM THE SITE WILL BE DEPOSITED IN THE DUMPSTER THE DUMPSTER WILL BE EMPITED A MINUMO FINGE A WEEK OR MORE OFTEN IF NECESSARY, AND THE TRASH WILL BE HAULED TO THE APPROPPIATE COUNTY LOCATION FOR DUMPHING NO CONSTRUCTION MATERIALS WILL BE BURIED ON—SITE. ALL PERSONNEL WILL BE INSTRUCTED RECARDING THE CORRECT PROCEDURE FOR WASTE DISPOSAL NOTICES STATING THESE PRACTICES WILL BE POSTED IN THE ON—SITE OFFICE TRAILER AND THE CONSTRUCTION MANAGER RESPONSIBLE FOR THE DAY—TO—DAY SITE OPERATIONS, WILL BE RESPONSIBLE FOR SEEING THAT THESE PROCEDURES ARE FOLLOWED.

HAZARDOUS WASTE-ALL HAZARDOUS WASTE MATERIALS, IF ENCOUNTERED, WILL BE DISPOSED OF IN THE MANNER SPECIFIED BY LOCAL OR STATE REGULATIONS. THE CONTRACTOR WILL BE RESPONSIBLE FOR SEEING THAT THESE PRACTICES ARE FOLLOWED

SANITARY WASTE-ALL SANITARY WASTE WILL BE COLLECTED FROM PORTABLE UNITS A MINIMUM OF THREE TIMES PER WEEK BY A LICENSED SANITARY WASTE MANAGEMENT CONTRACTOR, AS REQUIRED BY LOCAL REGULATION.

OFFSITE VEHICLE TRACKING

STABILIZED CONSTRUCTION ENTRANCES SHALL BE PROVIDED TO HELP REDUCE VEHICLE TRACKING OF SEDIMENTS. THE PAYED STREETS WILL BE CLEANED AS NEEDED TO REMOVE ANY EXCESS MULD DIRT OR ROCK TRACKED FROM THE SITE. DUMP TRUCKS HAULING MATERIAL FROM OR TO THE SITE WILL BE COVERED WITH A TARPUALIN AT

TIMING OF CONTROL MEASURES

AS INDICATED IN THE SEQUENCE OF MAJOR ACTIVITIES, STAKED SILT BARRIERS, TURBIDITY BARRIERS, STABILIZED CONSTRUCTION ENTRANCES AND COMPENSATION AREAS WILL BE CONSTRUCTED PRIOR TO GRUBBING OR GRADING OF ANY OTHER PORTIONS OF THE SITE. AREAS WHERE CONSTRUCTION ACTIVITY TEMPORARILY CEASES FOR MORE THAN 21 DAYS WILL BE STABILIZED WITH A TEMPORARY GRASS AND MULCH WITHIN 14 DAYS OF THE LAST DISTURBANCE. ONCE CONSTRUCTED ACTIVITY CEASES PERMANENTLY IN THAT AREA, THAT AREA WILL BE STABILIZED WITH PERMANENTS OD AFTER THE ENTIRE SITE IS STABILIZED. THE ACCUMILATED SEDIMENT WILL BE REMOVED FROM THE TRAPS AND THE STAKED SILT BARRIERS WILL BE REMOVED.

MAINTENANCE INSPECTION PROCEDURES

MAINTENANCE INSPECTION PROCEDURES

EROSION AND SEDIMENT CONTROL INSPECTION AND MAINTENANCE PRACTICES: THESE ARE THE INSPECTION AND MAINTENANCE PRACTICES: THAT SHALL BE USED TO MAINTENANCE PRACTICES THAT SHALL BE USED TO MAINTENANCE IN EAST ONCE CACH MEEN AND FOLLOWING ANY STORM EVENT OF 0.5 INCHES OR GREATER BY A CONTRACTOR'S REPRESENTATIVE. ALL MEASURES WILL BE INSPECTED TO 0.5 INCHES OR GREATER BY A CONTRACTOR'S REPRESENTATIVE. ALL MEASURES WILL BE MAINTAINED IN GOOD WORKING ORDER; F A REPAIR IS NECESSARY, IT WILL BE INSPECTED REQULARLY FOR DEPTH OF SEDIMENT, TEARS, TO SEE IF THE FABRIC IS SECURELY ATTACHED TO THE FENCE POSTS, AND TO SEE THAT THE FENCE POSTS ARE FIRMLY IN THE GROUND. THE SEDIMENT BASINS WILL BE INSPECTED FOR DEPTH OF SEDIMENT WILL BE REMOYED FOR DEPTH OF SEDIMENT ASSINS WILL BE INSPECTED FOR DEPTH OF SEDIMENT WILL BE REMOYED FOR DEPTH OF SEDIMENT ASSINS WILL BE INSPECTED FOR DEPTH OF SET INSPECTED FOR BARE SPOTS, MISSING WILL BE INSPECTED FOR DEPTH OF REPLACED IF PRECEDENT OF REPLACED IF PRECEDENT OF SET INSPECTED FOR BARE SPOTS, MISSING MULCHING REPORT IN PROPERTY AND ADJUSTED OR REPLACED IF PRECEDENT OF SET IN THE FORM THE PROPERTY OF SET INSPECTED REGULARLY AND ADJUSTED OR REPLACED IF PRECEDENT WILL BE MADE AFTER EACH INSPECTED REGULARLY AND ADJUSTED OR REPLACED IF PRECEDENT WILL SELECT INDIVIDUALS WHO WILL BE RESPONSIBLE FOR MAINTENANCE REPORT WILL SELECT INDIVIDUALS WHO WILL BE RESPONSIBLE FOR MAINTENANCE AND SHALL BE WEET IN AN ACTIVE LOOR FRAIL SELECT INDIVIDUALS WHO WILL BE RESPONSIBLE FOR MAINTENANCE AND TERPIR ACTIVITIES FILLING

THE STORMWATER PONDS HAVE BEEN DESIGNED BY A PROFESSIONAL ENGINEER TO PROVIDE ADEQUATE QUALITY TREATMENT AND ATTENDATION. THE STORMWATER SYSTEM CONSISTS OF OWNSTE STORMWATER PIPES THAT DRAINS INTO RETENTION PONDS. THE STORMWATER OVERFLOW WILL DRAIN INTO AN EXISTING DITCH LOCATED EAST OF THE PROPERTY. THE STORM WATER MANAGEMENT SYSTEM SHALL BE DESIGNED IN ACCORDANCE WITH THE CONSTRUCTION DOCUMENTS.

NON-STORM WATER DISCHARGES

IT IS EXPECTED THAT THE FOLLOWING NON-STORM WATER DISCHARGES WILL OCCUR FROM THE SITE DURING THE CONSTRUCTION PERIOD: THERE ARE NO NON-STORMWATER DISCHARGES.

SPILL PREVENTION

MATERIAL MANAGEMENT PRACTICES

THE FOLLOWING ARE THE MATERIAL MANAGEMENT PRACTICES THAT WILL BE USED TO REDUCE THE RISK OF SPILLS OR OTHER ACCIDENTAL EXPOSURE OF MATERIALS AND SUBSTANCES TO STORM WATER RUNDEF.

GOOD HOUSEKEEPING:
THE FOLLOWING GOOD HOUSEKEEPING PRACTICES SHALL BE FOLLOWED
ON-SITE DURING THE CONSTRUCTION PROJECT.

AN EFFORT SHALL BE MADE TO STORE ONLY ENOUGH PRODUCT REQUIRED TO DO THE JOB. ALL MATERIALS STORED ON—SITE SHALL BE STORED IN A NEAT, ORDERLY MANNER IN THEIR APPROPRIATE CONTAINERS AND, IF POSSBILE, UNDER A ROOF OR OTHER CONTAINED ENCLOSURE, PRODUCTS SHALL BE KEPT IN THEIR ORIGINAL MANUFACTURER'S LABELDE CONTAINERS SUBSTANCES SHALL NOT BE MIXED WITH ONE ANOTHER UNLESS RECOMMENDED BY THE MANUFACTURER WHENEVER POSSIBLE, ALL OF A PRODUCT SHALL BE USED UP BEFORE DISPOSING OF THE CONTAINER MANUFACTURERS RECOMMENDATIONS FOR PROPER USE AND DISPOSAL SHALL BE COLLOWED, THE SITE SUPERINTENDERS SHALL INSPECT DAILY TO ENSURE PROPER USE AND DISPOSAL OF MATERIALS ON—SITE.

THE FOLLOWING PRODUCT SPECIFIC PRACTICES WILL BE FOLLOWED ON-SITE-

HAZARDOUS PRODUCTS:

THESE PRACTICES ARE USED TO REDUCE THE RISKS ASSOCIATED WITH HAZARDOUS MATERIALS. PRODUCTS SHALL BE KEPT IN ORIGINAL CONTAINERS UNLESS THEY ARE NOT RESCALABLE. ORIGINAL LABELS AND MATERIAL SAFETY DATA SHALL BE RETAINED: THEY CONTAIN IMPORTANT PRODUCT INFORMATION IF SURPLUS PRODUCT WIST BE DISPOSED OF, MANUFACTURERS OR LOCAL AND STATE RECOMMENDED METHODS OF PROPER DISPOSAL SHALL BE FOLLOWED.

PETROLEUM PRODUCTS:

ALL ON-SITE VEHICLES WILL BE MONITORED FOR LEAKS AND RECEIVE REGULAR PREVENTIVE MAINTENANCE TO REDUCE THE CHANGE OF LEAKAGE PETROLEUM PRODUCTS WILL BE STORED IN TIGHTLY SEALED CONTAINERS, WHICH ARE CLEARLY LABELED ANY ASPHALT SUBSTANCES USED ON-SITE WILL BE APPLIED

FERTILIZERS:

FERTILIZERS USED WILL BE APPLIED ONLY IN THE MINIMUM AMOUNTS RECOMMENDED BY THE MANUFACTURER. ONCE APPLIED, FERTILIZER WILL BE WORKED INTO THE SOIL TO LIMIT EXPOSURE TO STORMWATER. STORAGE WILL BE IN A SEALABLE PLASTIC BIN TO AVOID SPILLS

CONTRACTOR SHALL DESIGNATE AN AREA FOR DISCHARGE OF SURPLUS CONCRETE OR DRUM WASH WATER AND SHALL INSTALL A CONTAINMENT BERM AROUND THIS AREA TO PREVENT RUNOFF TO THE REMAINDER OF THE SITE. HARD DEBRIS SHALL BE DISPOSED OF BY CONTRACTOR UPON COMPLETION OF THE PROJECT.

INVENTORY FOR POLLUTION PREVENTION PLAN

THE MATERIALS OR SUBSTANCES LISTED BELOW ARE EXPECTED, BUT NOT LIMITED, TO BE PRESENT ON-SITE DURING CONSTRUCTION:

CONCRETE DETERGENTS SAND STONE

FERTULIZERS

PETROLEUM BASED PRODUCTS, TAR, AND FUELS CLEANING SOLVENTS

NOTICE OF INTENT (NOI) - KEY PROVISIONS

1 IMPLEMENTATION OF THIS STORMWATER POLLUTION PREVENTION PLAN (SWPPP).
2 CONDUCTING AND DOCUMENTING ROUTINE INSECTIONS AS REQUIRED
3 PETENTION OF RECORDS REQUIRED BY THE PERMIT INCLUDING RETENTION OF
A COPY OF THE SWPPP AT THE CONSTRUCTION SITE, FROM THE DATE OF
PROJECT INITIATION TO THE DATE OF FINAL SITE STABILIZATION
4. IF THE PROJECT WILL CONTINUE DISCHARGING STORMWATER ASSOCIATED WITH
CONSTRUCTION ACTIVITY BEYOND EXPIRATION OF THE CURRENT COVERAGE.
REQUEST FOR CONTINUED COVERAGE SHALL BE MADE BY FILLING A
COMPLETED NOI AT LEAST 2 DAYS BEFORE EXPIRATION OF THE CURRENT
COVERAGE PERIOD.

NOTICE OF TERMINATION (NOT)

A NOTICE OF TERMINATION (NOT) WILL BE SUBMITTED TO THE FLORIDA DEPARTMENT OF ENVIRONMENTAL PROTECTION (FDEP) AFTER THE CONSTRUCTION HAS BEEN COMPLETED AND THE SITE HAS UNDERGONE FINAL STABILIZATION BY THE CONTRACTOR.

POLLUTION PREVENTION PLAN CERTIFICATION

I CERTIFY UNDER PENALTY OF LAW THAT THIS DOCUMENT AND ALL ATTACHMENTS HAVE BEEN READ BY ME OR MY DESIGNATED REPRESENTATIVE AND UNDERSTAND THAT THIS SYSTEM HAS BEEN PREPARED TO ASSURE THAT OLUMIFED PERSONNEL PROPERLY GATHER AND EVALUATE THE INFORMATION SUBMITTED. BASED ON MY NOULIRY OF THE PERSONS WHO MANAGE THE SYSTEM, OR THOSE PERSONS DIRECTLY RESPONSIBLE FOR GATHERING THE INFORMATION SUBMITTED IS, TO THE BEST OF MY KNOWLEDGE AND BELIEF, TRUE, ACCURATE AND COMPLETE. I AM AWARE THAT THERE ARE SIGNIFICANT PENALTRES FOR SUBMITTING FALSE INFORMATION, INCLUDING THE POSSIBILITY OF FINE AND IMPRISONMENT FOR KNOWING VIOLATIONS.

SIGNED:		
NAME ANI) TITLE:	
ADDRESS:	9500 BAY PINES BOULEVARD	
	ST. PETERSBURG, FL	
	PH: (727) 319-5995	

CONTRACTOR'S AND ENGINEER'S CERTIFICATION

CERTIFY UNDER PENALTY OF LAW THAT I UNDERSTAND THE TERMS AND CONDITIONS OF THE GENERAL NATIONAL POLLUTANT DISCHARGE ELIMINATION SYSTEM (NPDES) PERMIT THAT AUTHORIZES THE STORMWATER DISCHARGES ASSOCIATED WITH CONSTRUCTION ACTIVITY FROM THE CONSTRUCTION SITE IDENTIFIED AS PART OF THIS CERTIFICATION I UNDERSTAND, AND SHALL COMPLY WITH THE TERMS AND CONDITIONS OF THE STATE OF FLORINA "GENERIC PERMIT FOR STORMWATER DISCHARGE FROM LARGE AND SMALL CONSTRUCTION ACTIVITES" (COP), AND THIS STORMWATER POLLUTION DREVENTION PLAN PREPARED FOR THE PROPOSED PUBLIC WORKS BUILDING IN PASCO COUNTY, FL.

	SIGNATURE:	FOR:	RESPONSIBLE FOR:
-	AME:	COMPANY: ADDRESS:	GENERAL CONTRACTOR
Ξ	ATE:	PHONE:	
		COMPANY: ADDRESS:	TEMPORARY AND PERMANENT STABILIZATION
D	ATE:	PHONE:	CONSTRUCTION ENTRANCE EARTH DIKES
-		COMPANY: ADDRESS:	WETLAND MITIGATION / COMPENSATION AREA
D	ATE:	PHONE:	_

_		
	CERTIFIED ENGINEER	
	NAME: THOMAS M. ROSE, PE	
	TITLE: PROJECT MANAGER	
	COMPANY: THE GROUP, INC.	
	20203 CORTEZ BOULEVARD	
	BROOKSVILLE, FL 34601	DATE:
	PHBNE: 352-754-4551	FL. REG. NO. 62860

NOTICE OF INTENT (NOI)

THE FLORIDA DEPARTMENT OF ENVIRONMENTAL PROTECTION HAS RECEIVED AND PROCESSED THE "NOTICE OF INTENT TO USE CREATED PROTECTION HAS RELEVED AND PROCESSED THE "NOTICE OF INTENT TO USE CREATE PROTECTION ACTIVITIES" (NO!). THE PROJECT IS COVERED UNDER THE CENERIC PERMIT EFFECTIVE, AND EXPIRES ON THE PROJECT IDENTIFICATION NUMBER IS FLR.

VETERANS ADMINISTRATION		
SERVICES		
OEI(TIOEO		

BY DATE



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THOMAS M. ROSE PE DATE LIC. NO.: 62860

DESIGNED DRAWN Q.C. APPROVED

00081.001.00 DATE: MAY 2008

PROJECT NO:


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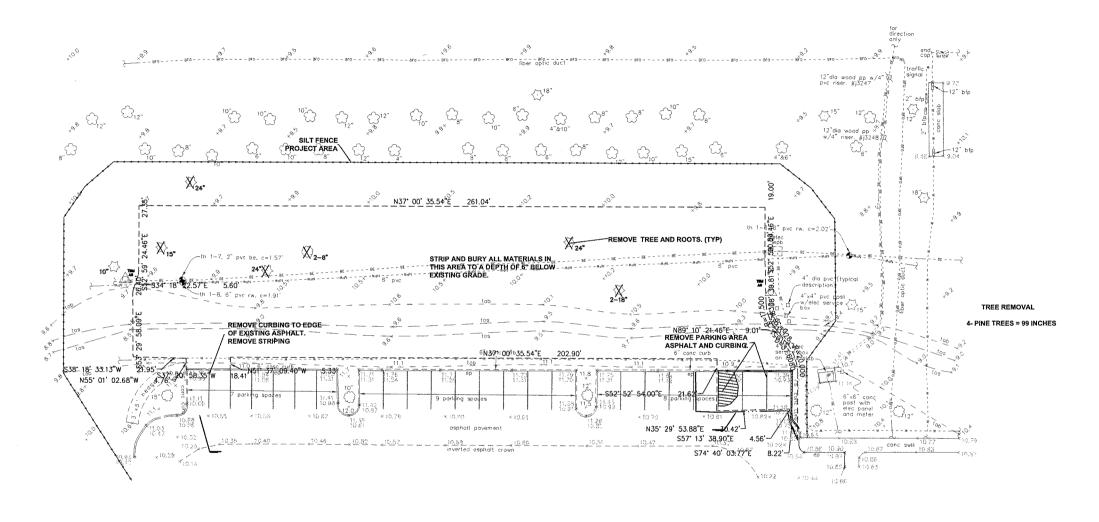
NO.

SWPP PLAN

SHEET NO:

SC1.01



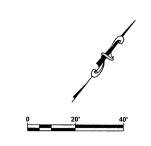

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SWFWMD SUBMITTAL	PEM	9-29-2008	
DESCRIPTION	BY	DATE	
	SWFWMD SUBMITTAL	SWFWMD SUBMITTAL PEM	SWFWMD SUBMITTAL PEM 9-29-2008

VETERANS ADMINISTRATION SERVICES

ADDITIONAL PARKING LOTS

GROUP


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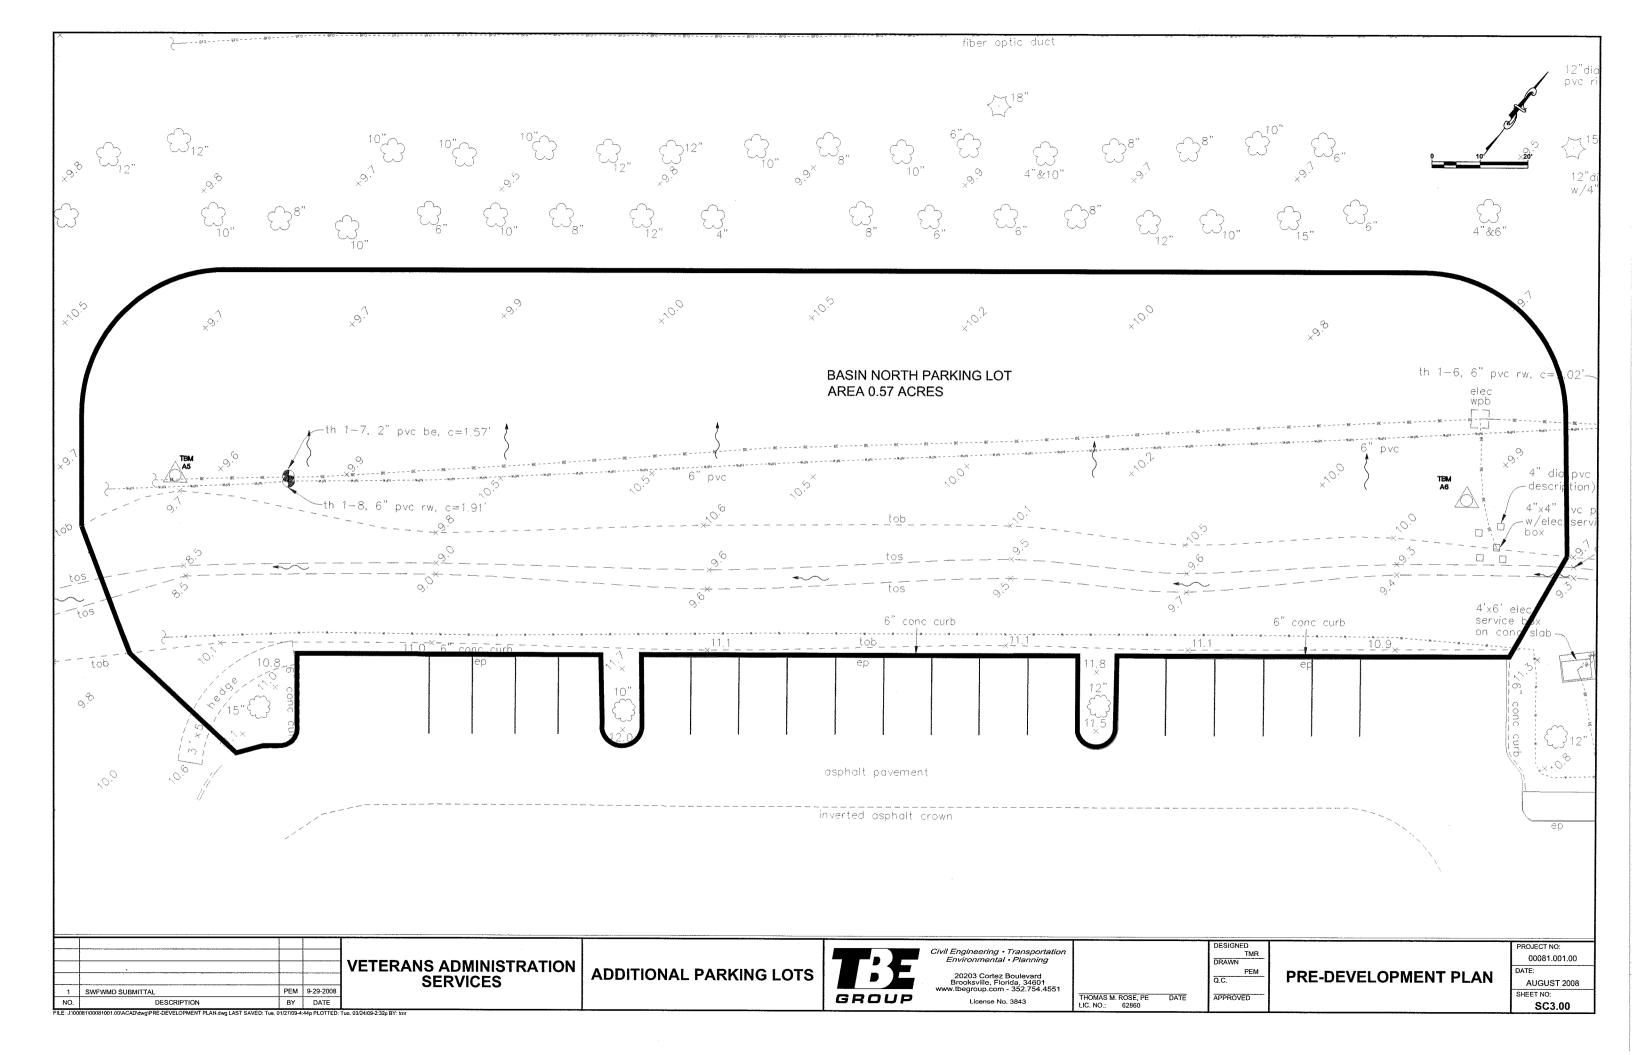
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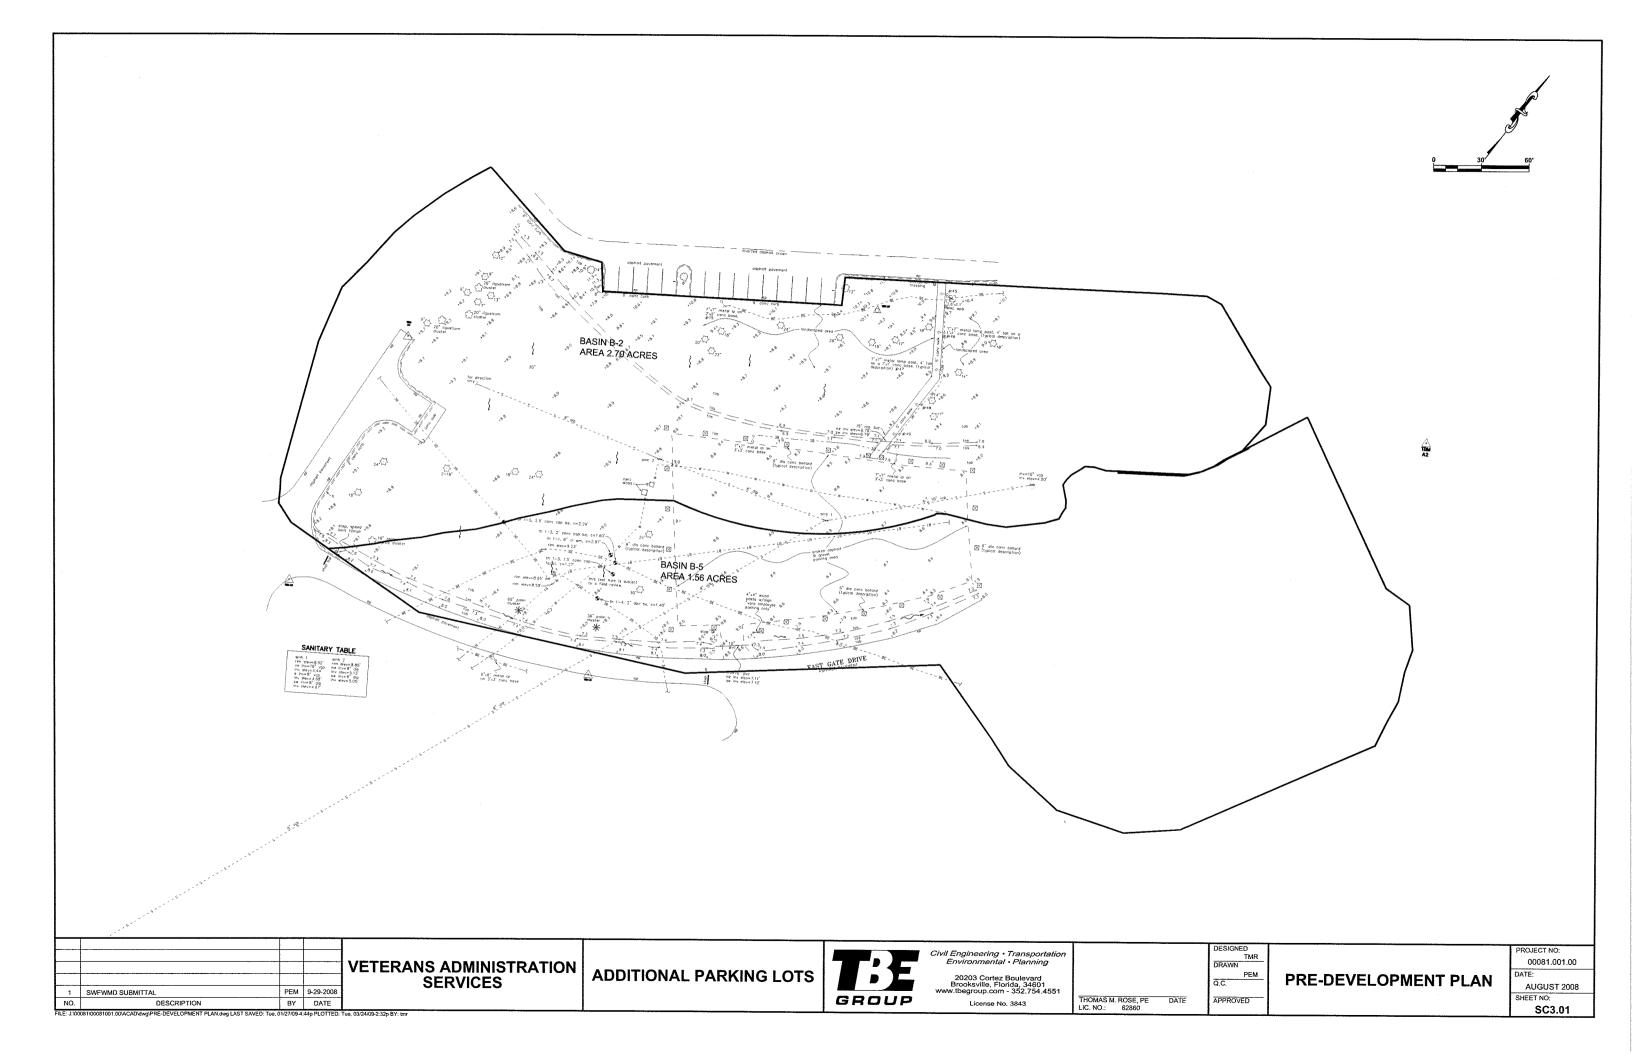
DEMOLITION PLAN


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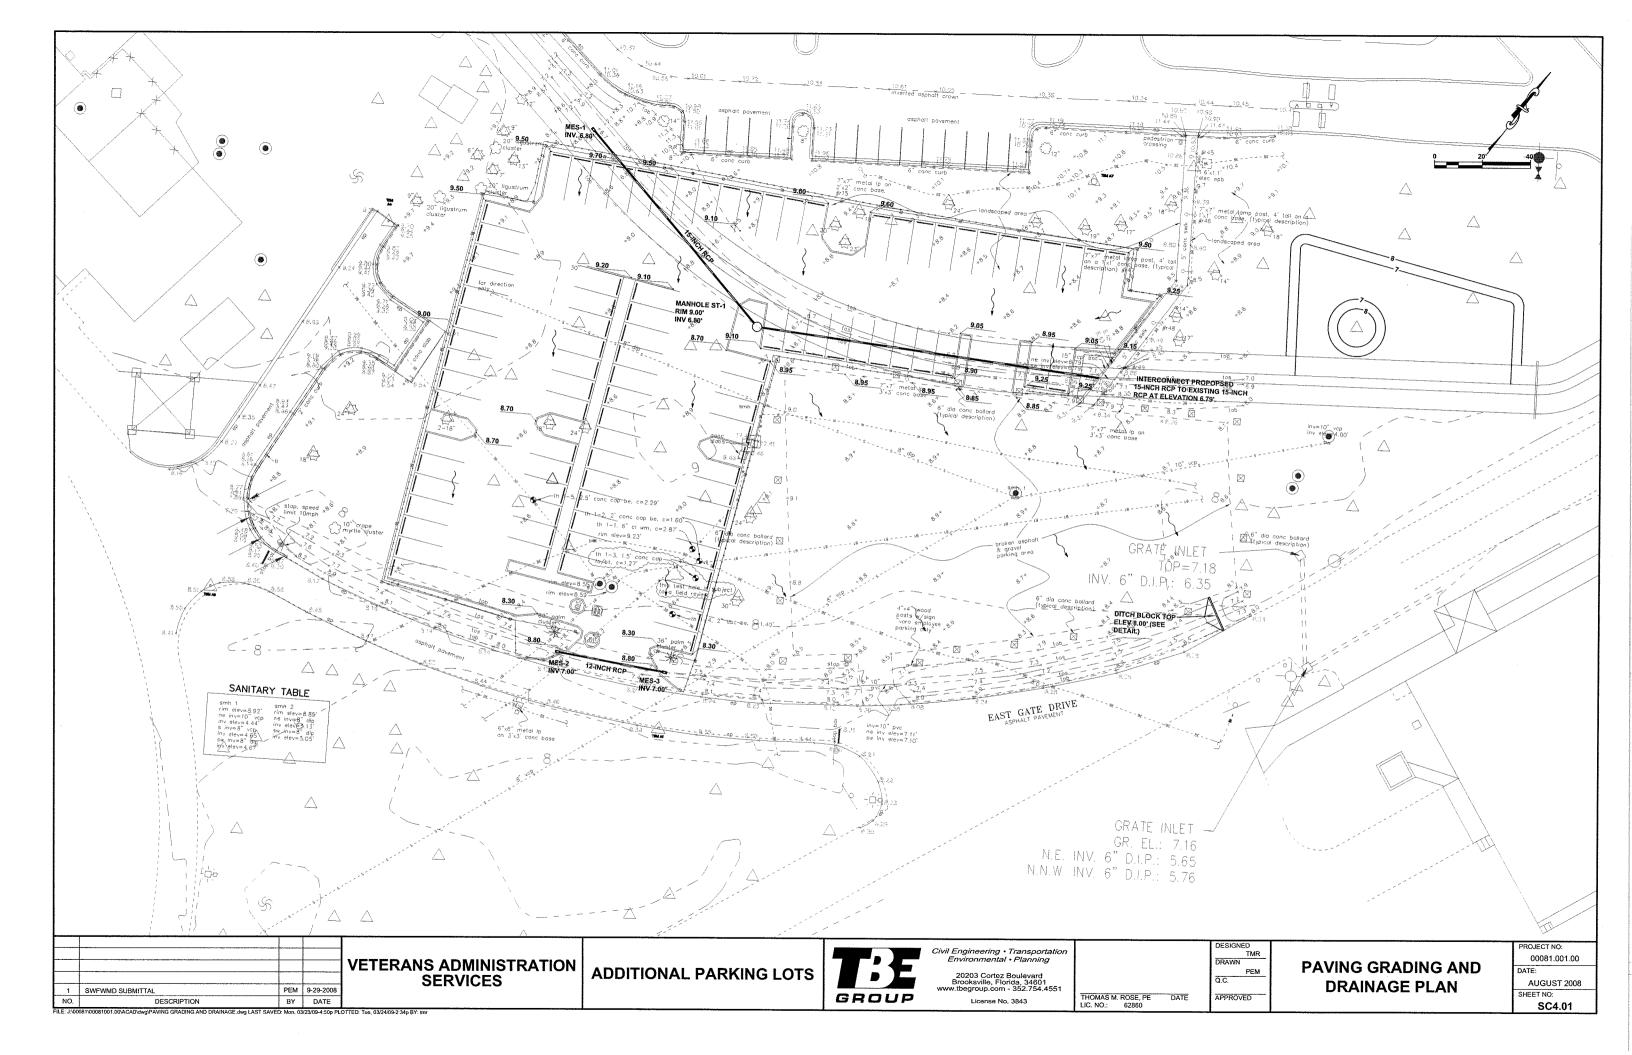
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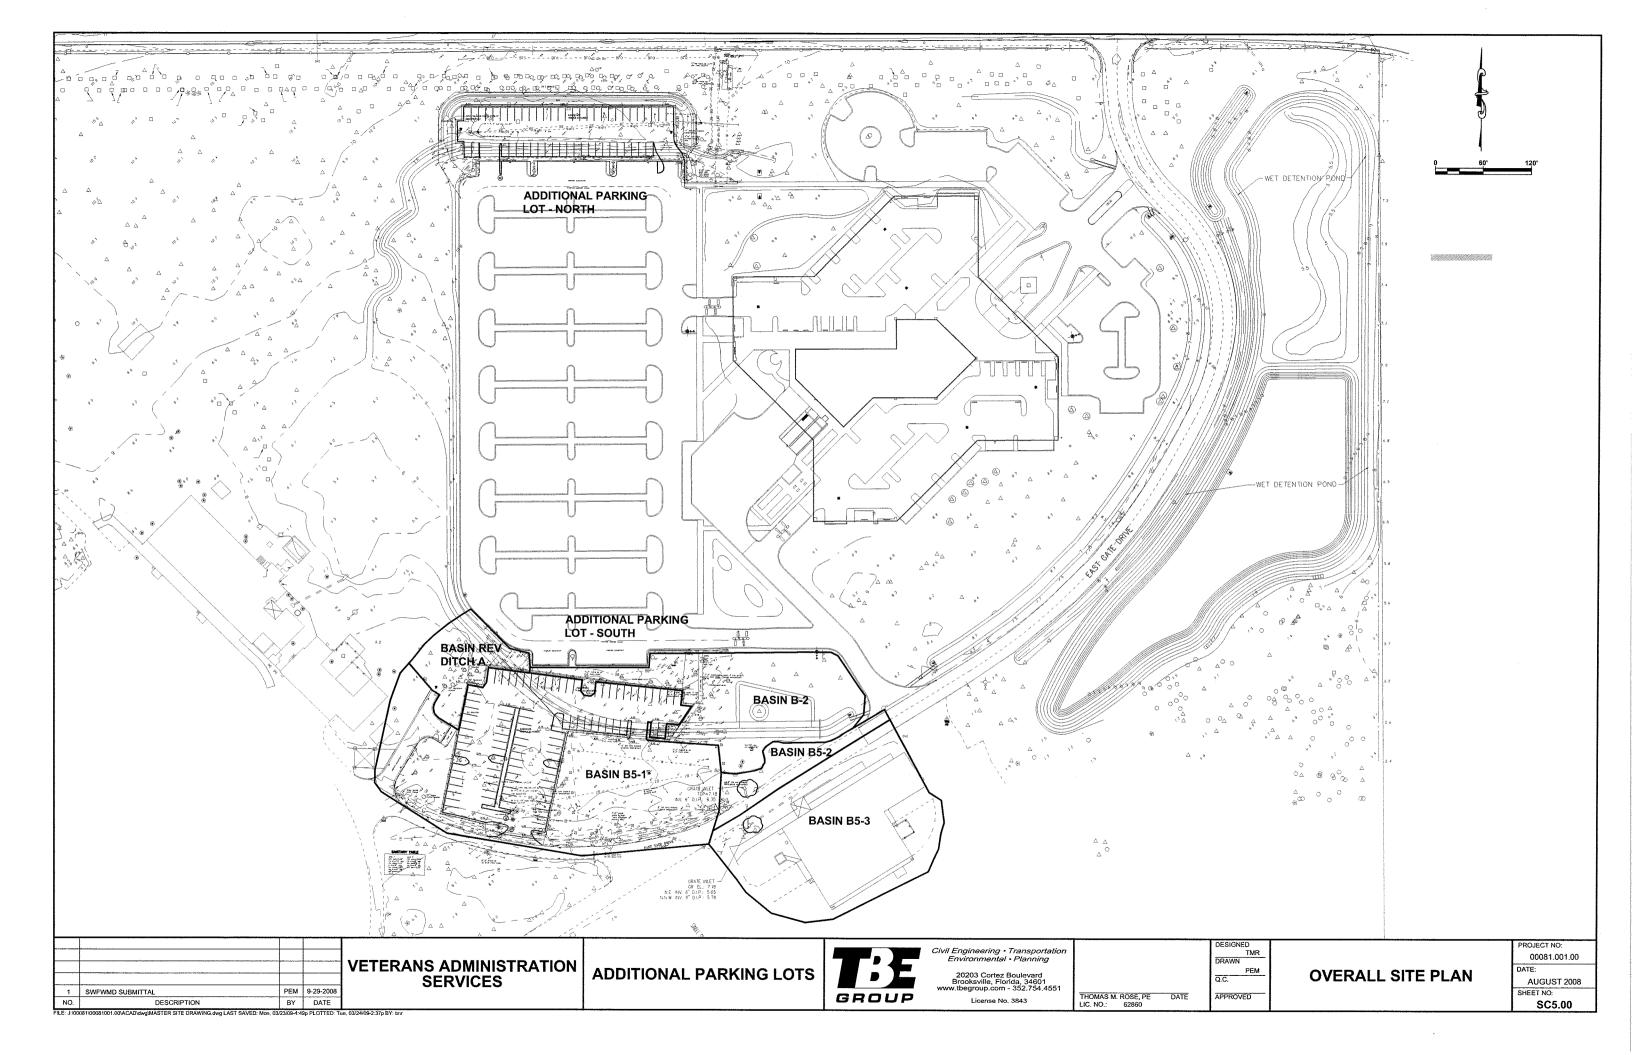











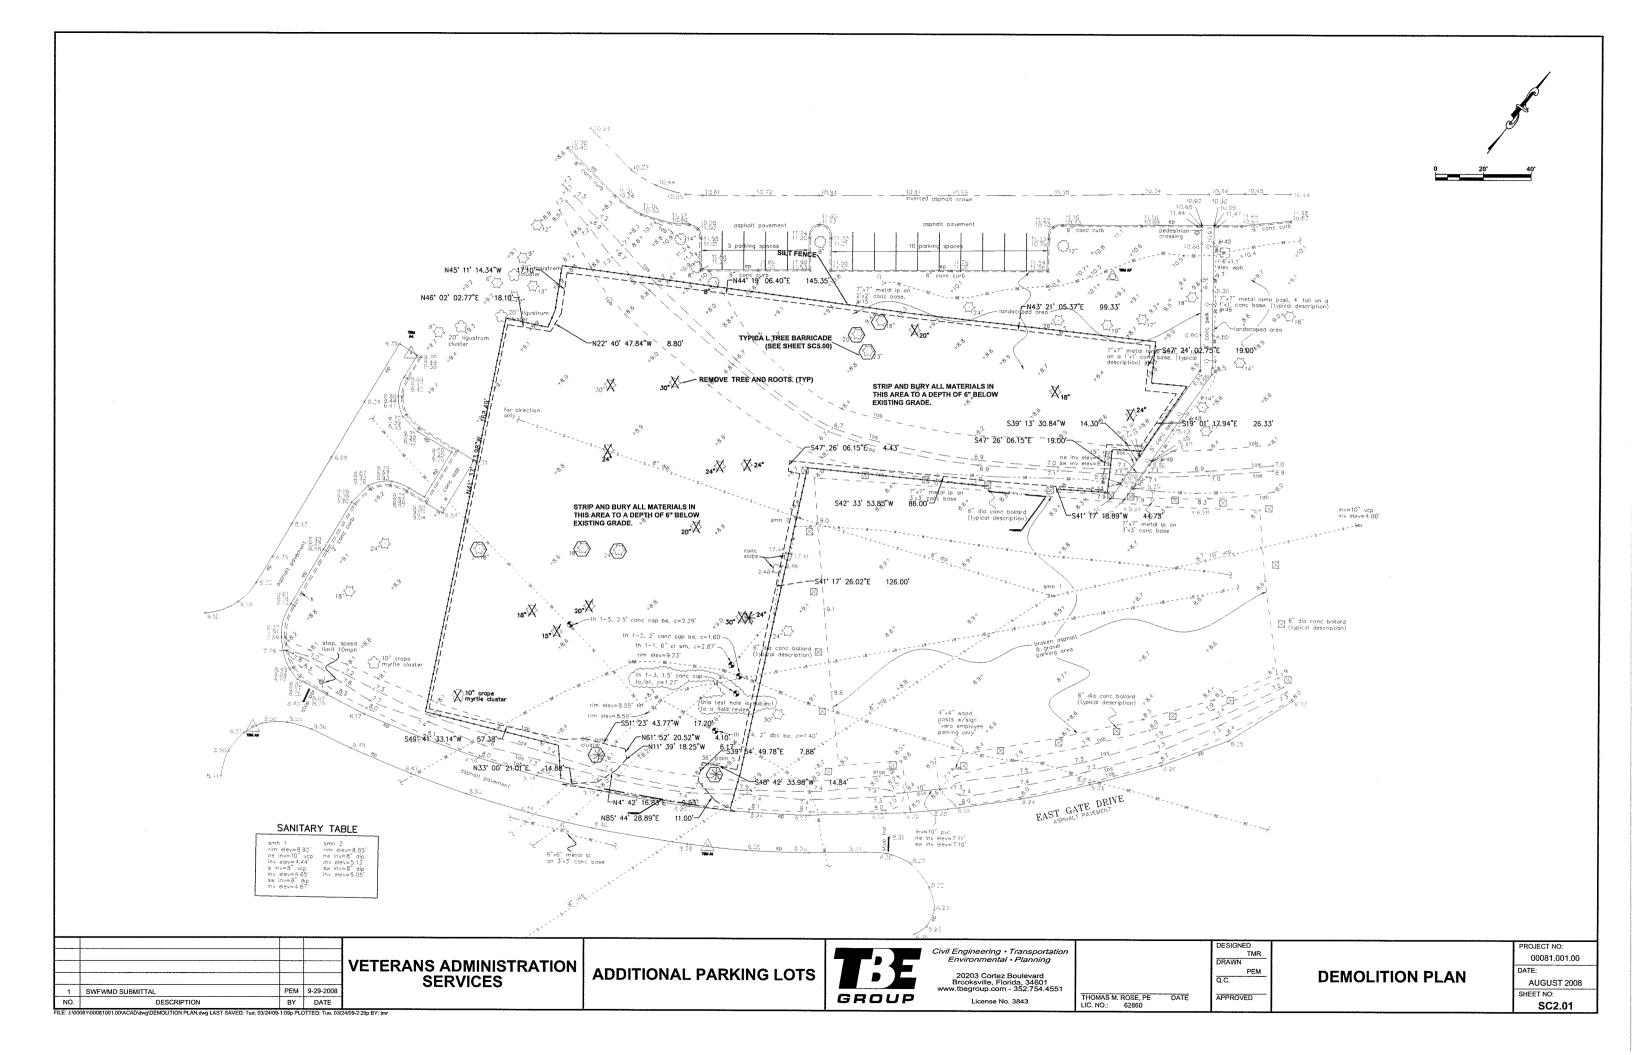

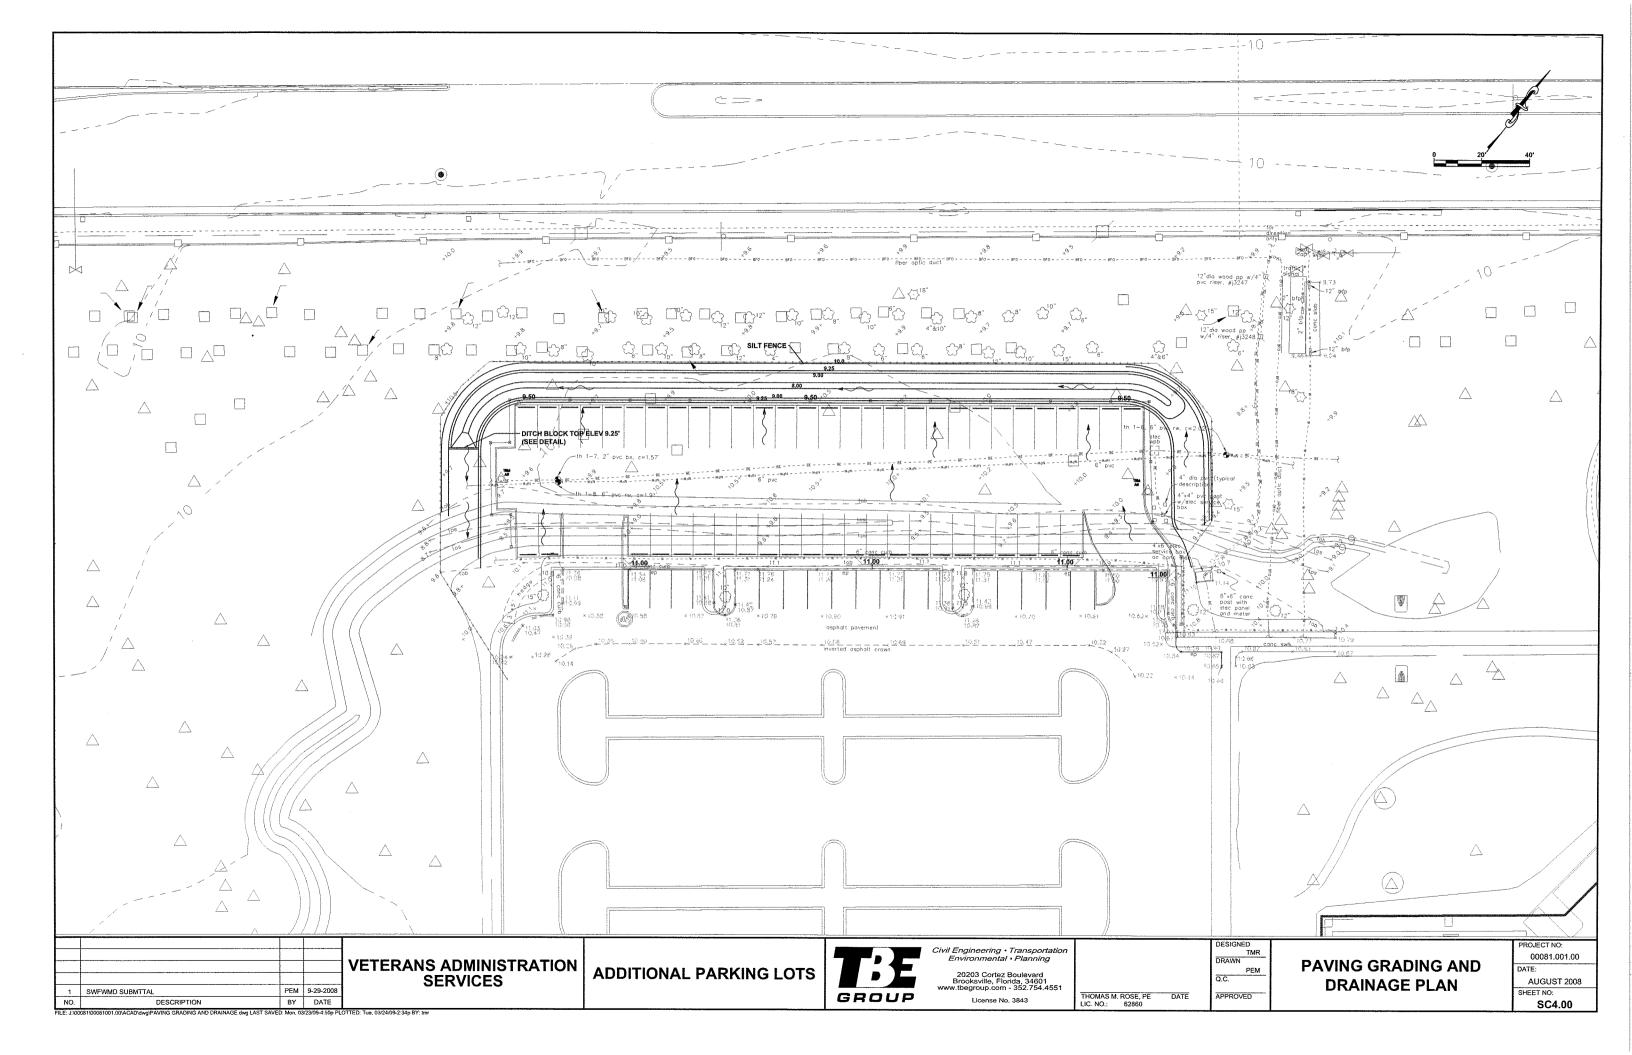

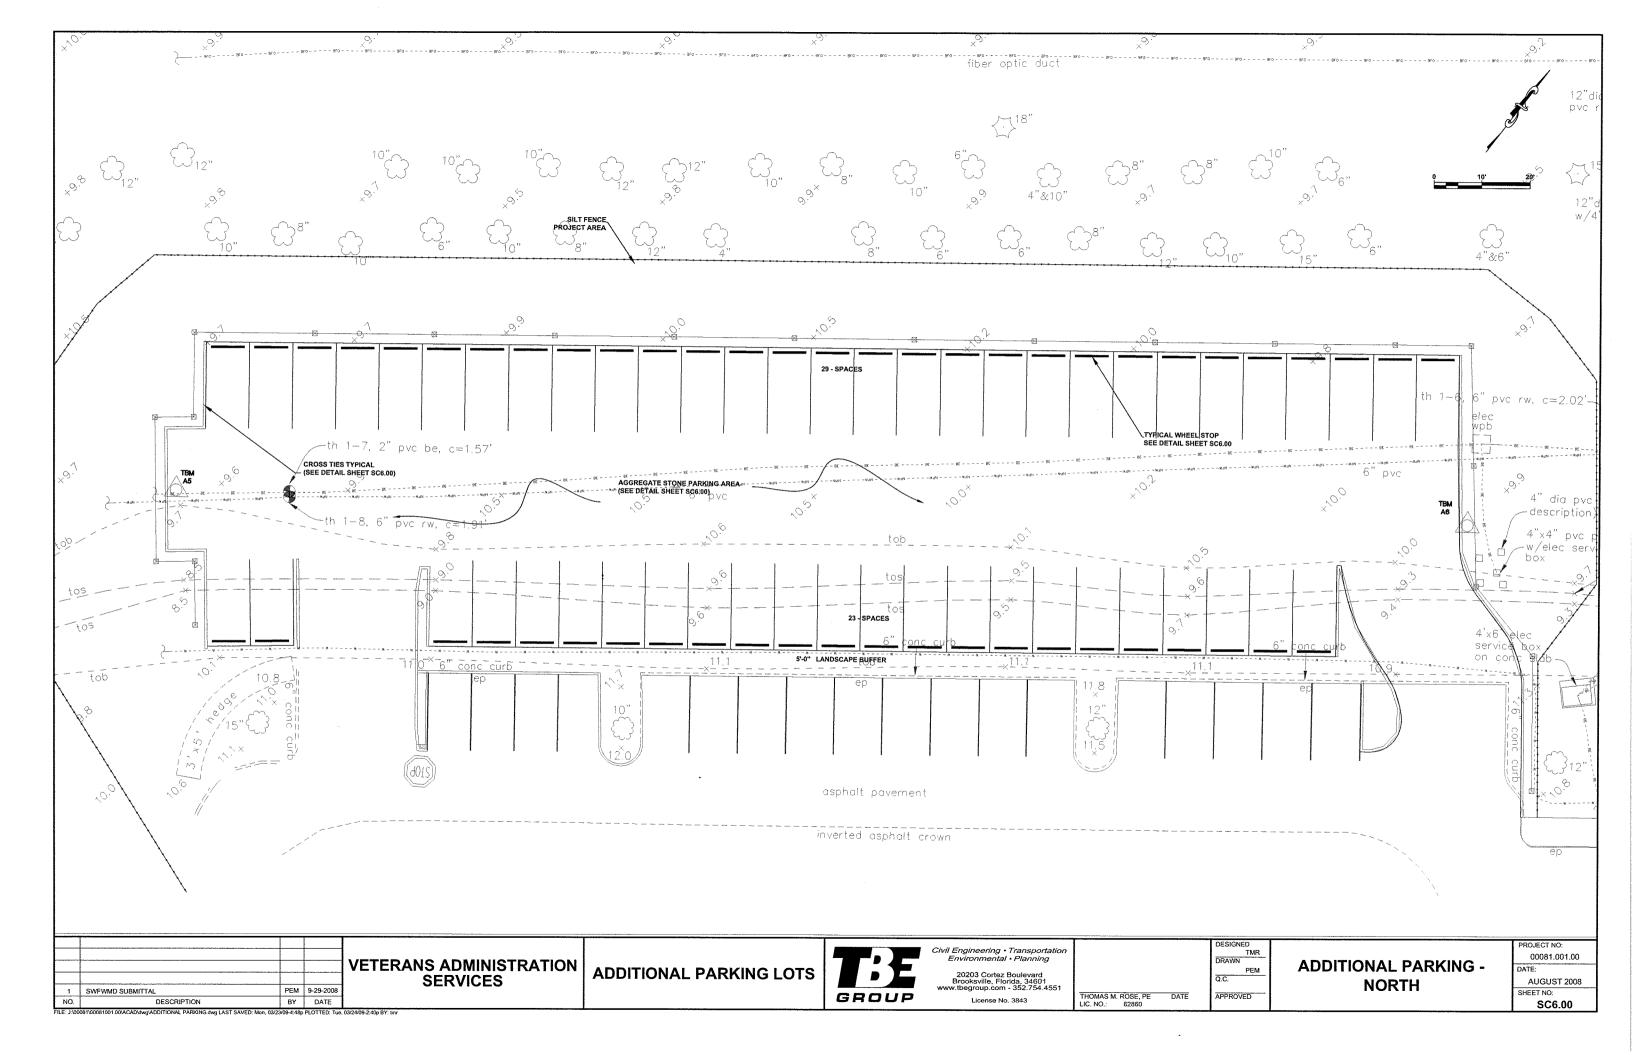

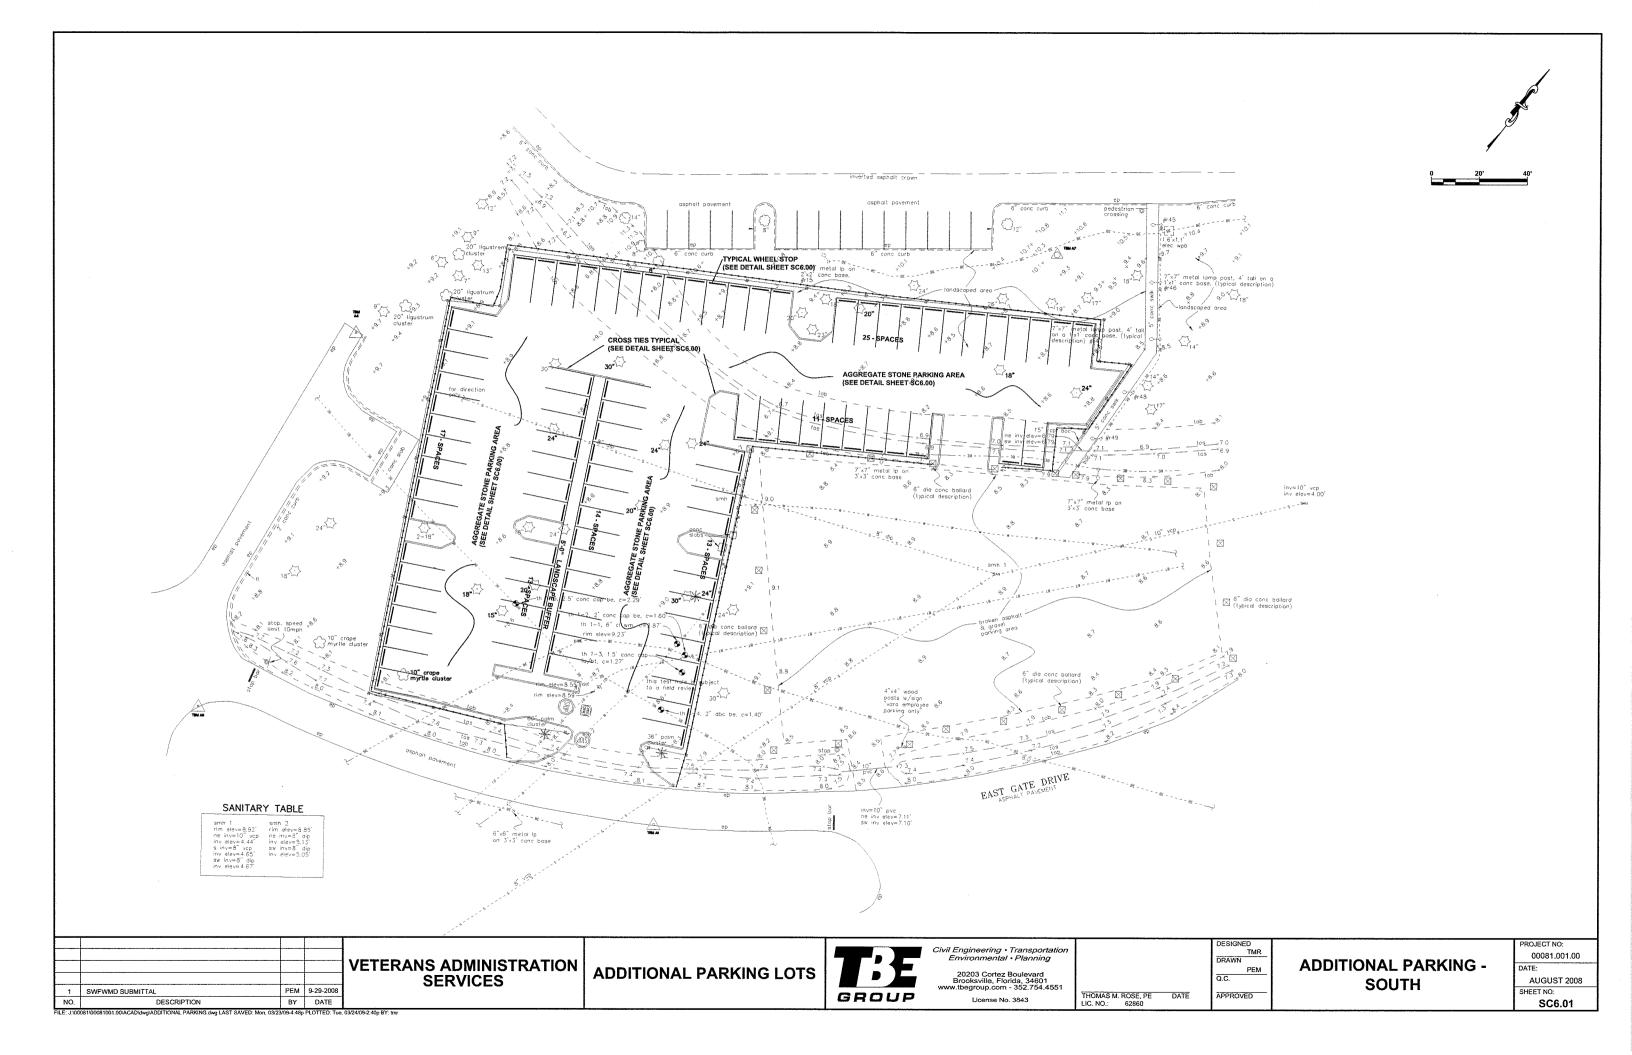

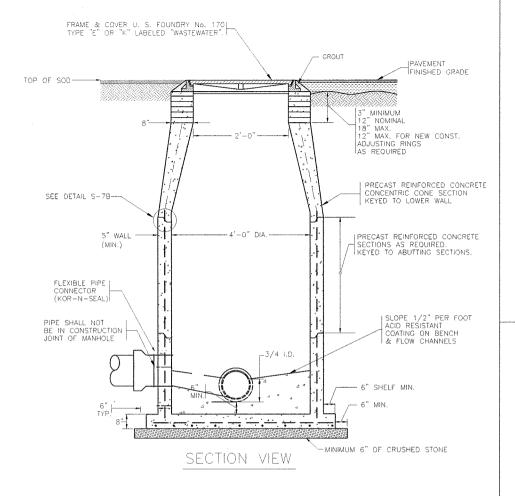



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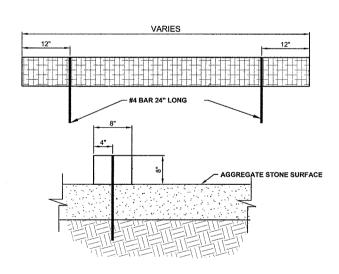
ALL STANDARD MANHOLE NOTES APPLY. REFER TO EXHIBIT No. S-7c. DETAIL APPLIES TO MANHOLES WITH DEPTHS OF 6' TO 15'.

STANDARD 48" PRECAST MANHOLE FOR SEWERS 16" OR LESS IN DIA. HILLSBOROUGH COUNTY, FLORIDA


1/00 SCALE: N.T.S.



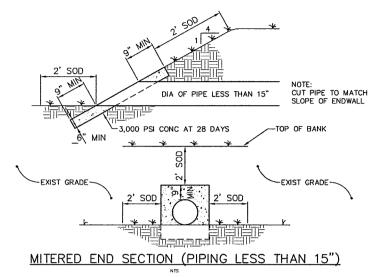


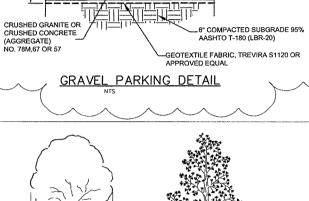

CROSS TIES AND WHEEL STOP DETAIL

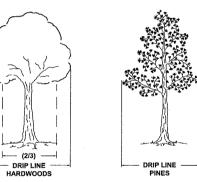

REQUIRED DISTANCES FROM TREE TRUNK

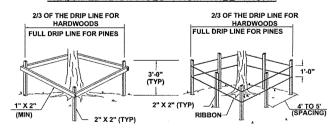

TYPE A BARRIER

TYPE B BARRIER

SPECIAL NOTES:

- 1. NO TREE SHALL BE REMOVED UNLESS SPECIFICALLY TAGGED FOR REMOVAL BY THE
- ENGINEER.

 2. THE CONTRACTOR SHALL TAKE SPECIAL CARE NOT TO DAMAGE TREES THAT ARE TO REMAIN. 3. ROOTS GREATER THAN 1" DIAMETER SHALL NOT BE CUT UNLESS OTHERWISE APPROVED BY
- 4. TREE ROOTS OF 1" DIAMETER OR LARGER THAT NEED TO BE CUT SHALL BE CUT NEATLY. 5. STOCKPILED MATERIALS OR UNNECESSARY VEHICULAR TRAFFIC SHALL NOT BE ALLOWED OVER ANY TREE ROOTS SYSTEM.
- 6. TYPE-A BARRIER OR TYPE-B BARRIER SHALL BE CONSTRUCTED WHEN CALLED FOR ON PLANS OR AS DIRECTED BY THE ENGINEER. BARRIERS SHALL BE MAINTAINED IN PLACE UNTIL REMOVAL IS DIRECTED BY THE ENGINEER.
- 7. COST OF ALL TREE BARRICADES SHALL BE INCLUDED IN PAY ITEM 120-1100 (GRADING).

2	REVISED GRAVEL PARKING DETAIL	PEM	10/20/08
1	SWFWMD SUBMITTAL	PEM	9-29-2008
NO.	DESCRIPTION	BY	DATE

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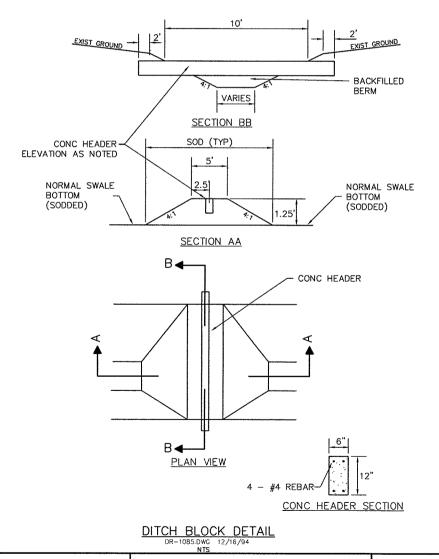
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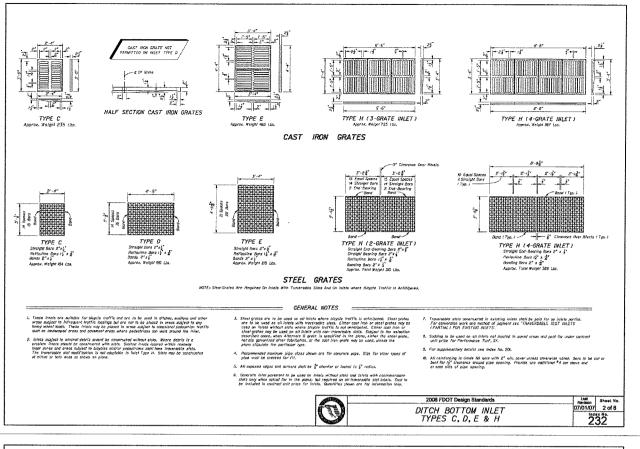
DRAWN PEM Q.C. THOMAS M. ROSE, PE LIC. NO.: 62860 APPROVED


SITE DETAILS

00081.001.00 AUGUST 2008

SHEET NO: SC7.00





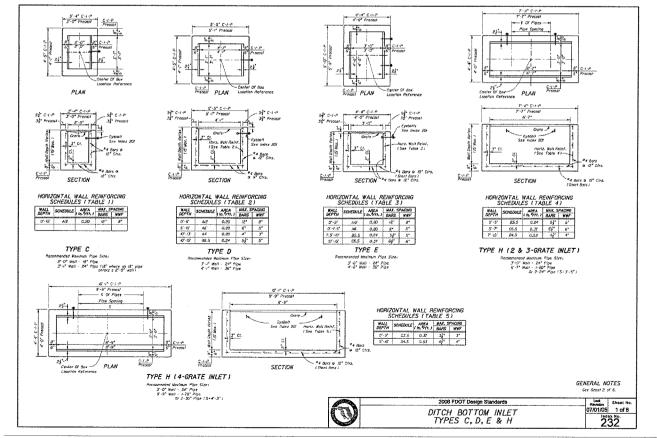



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SITE DETAILS

PROJECT NO: 00081.001.00 DATE:

AUGUST 2008 SHEET NO: SC7.01

